GREATER SUDBURY CAPITAL REDEVELOPMENT 1310 SPARKS STREET SUDBURY, ON



PROPOSED BUILDING - SOUTH EAST CORNER PERSPECTIVE VIEW FROM SPARKS STREET THREE STOREY 14 UNIT SENIORS HOUSING

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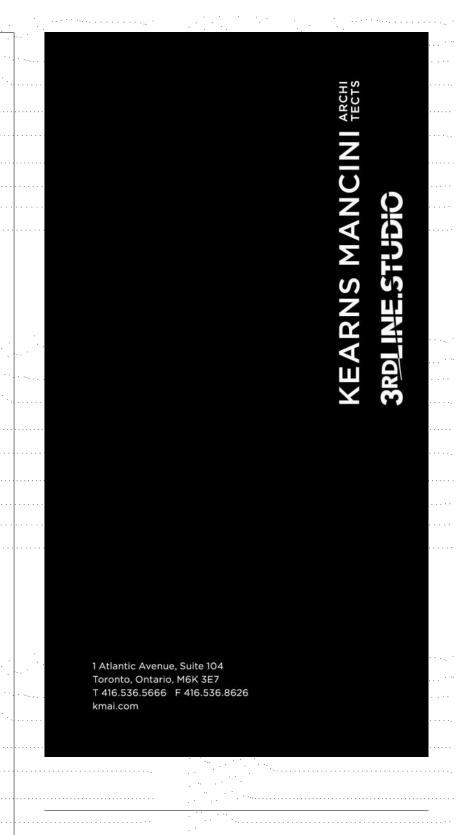
CIVIL	ENGINEER
	SERVICES

885 Regent Street
Sudbury, Ontario P3E 5M4
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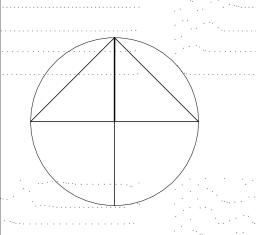
ARCHITECTURAL LIST				

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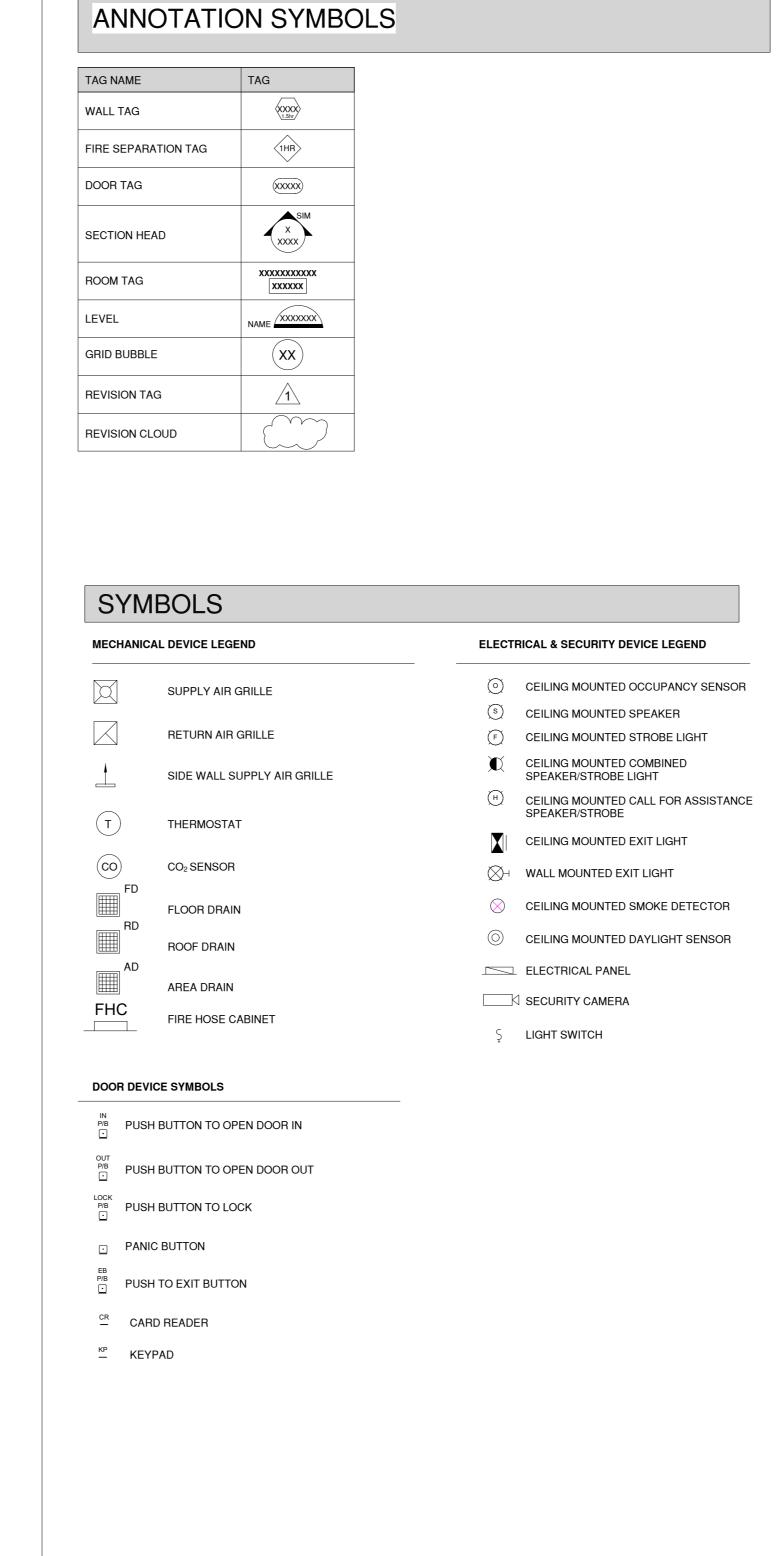
Greater Sudbury Capital Redevelopment


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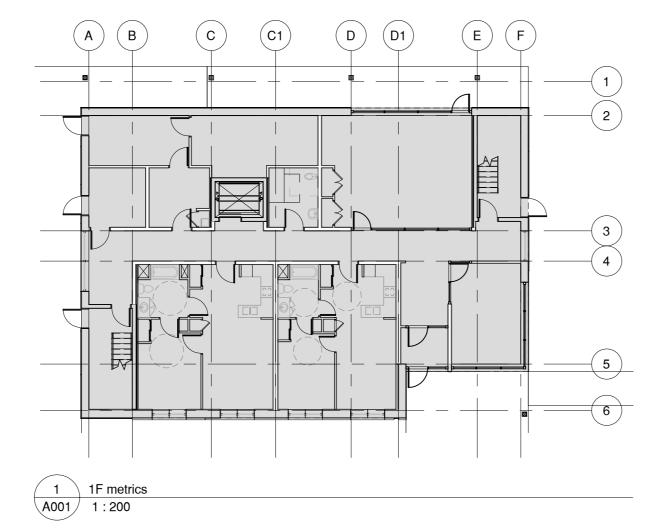
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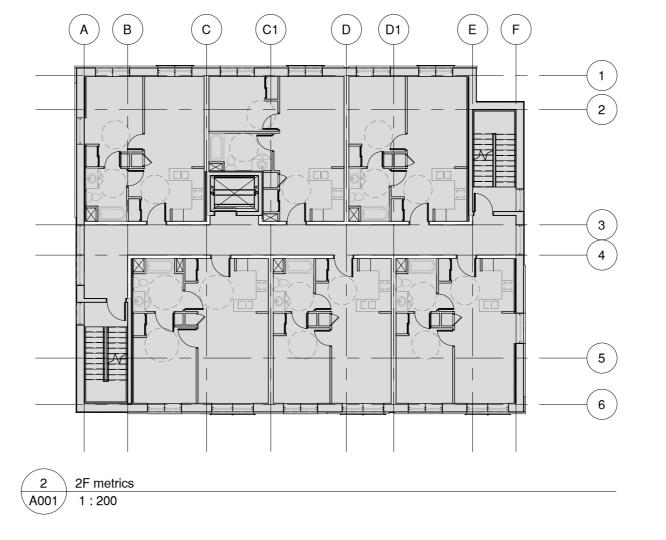
ABBREVIATIONS QT quarry tile EA each HB aluminium base centre hose bib m metre TA table top ABM air barrier membrane C-Top ED exit device HCWD MACH machine QTR quarter countertop hollow core wood top and bottom above each face hand dryer magnetic lock QUAL quality tongue and groove caliper EG end grain QTY quantity towel bar access exterior insulation and finish system HDRL cantilever handrail manual tackboard **HDWR** R riser architectural concrete finish catch basin electronic keypad material top of curb hardware ACP acoustic ceiling panel HEF MAX RA return air trench drain elevation concealed closer horizontal each face maximum ELEC electrical ACOUST acoustical RAD radius centre to centre hollow metal motorized control centre towel dispenser and receptacle ACR ELEV elevator CEM HM INS RB resilient base acrylic cement hollow metal insulated motorized damper telephone TEMP acoustic ceiling tile clear anodized finish EMERG emergency hold open MECH mechanical RBC resilient base coved temporary TERR area drain corner guard ENAM enamel HOF horizontal outside face medium reinforced concrete ADD coat hook ENCL enclosed high pressure laminate RCIC removed by contractor installed by contractor TERM ADH chair ероху metal RCIO removed by contractor installed by owner cast iron EQ equal hollow structural section MEZZ mezzanine RCP reflected ceiling plan adjustable automatic door operator EQUIP equipment manufactured RD roof drain control joint twist lock AES HTR REC recessed above existing slab centre line existing to be relocated manufactured top of lower layer MGTME make good to match existing RECP receptacle above finished floor closer EW HVAC to match existing each way heating ventilation and air conditioning REF reference AGG EWC electrical water cooler HWD CL/AN MH clear anodized hardwood man hole top of aggregate AHU air handling unit CLG REIN reinforced top of concrete clear laminated glass existing mounting height EXH REL relocate TOES CLR exhaust MIN aluminum clear included in contract minimum top of existing slab EX JT expansion joint ALC CLOS REQD required alcove closet inside dimension or inside diameter mirror top of slab alternate centimetre EXT exterior insulation and finish system millimetre REV revised, revision toilet partition EXP amount concrete masonry unit masonry opening resilient flooring transformer anodysed clean out metal acoustical panel RFG rigid fiberglass temperature rise rating F TO F face to face INFO MRT marble tile right hand TSTAT thermostat access pane column APPROX approximate CON FA fire alarm INSP mosaic tile RHR righthand reverse toilet tissue dispenser concrete COND FAB fabricate INSUL MTA meeting table RM room abuse resistant conduit top of upper layer insulation RO rough opening ARCH architectural CONN FATB from above to below MTD mounted connection interior typical CONST MTG FB fabric ROIC removed by owner installed by contractor acoustic sealant construction meeting CONT FBTA from below to above ROIO removed by owner installed by owner MUA make up air asbestos continuous inside undercut ASPH asphalt ROW right of way CONV foot candle unfinished ASSOC association carpet floor drain junction box N/A not applicable resin panel unit heater CPTT FDN foundation RPM revolutions per minute unless otherwise noted card reader fire extinguisher joint filler NFHB non freeze hose bib room scheduler air/vapour barrier unpainted AV control pad cold rolled channel not in contract resilient sheet flooring fire extinguisher cabinet janitor shelves under-side AVG JST RT rubber tread CRD factory finish NO average credenza number RTU | roof top unit AWP acoustic wall panel CRS finished floor elevation ioint NOM nominal VAR courses varnish FF&E fixtures, furnishings and equipment RUB rubber closet shelves near side vapour barrier RWL rainwater leader B TO B back to back FH NTS not to scale full height countersunk knockdown vinyl base coved RWS roller window shade BBD black board FHC fire hose cabinet ceramic tile kilogram vinyl base straight FIN baseboard heater towel dispenser/waste receptacle overall vinyl composite tile black chrome connect to existing FL floor VERT VEST between CTG FLUOR fluorescent outside dimension/diameter SB sandblasted vestibule clear tempered glass FND feminine napkin disposal bin brushed finish CTR SBO supplied by owner centre original equipment manufacture verical outside face FOC KPD bore hole complete with face of concrete keypad sawcut CW fireproof SCIC supplied by contractor installed by contractor VOS bituminous curtainwall overhead verify on site door frame bookcase crystalline waterproofing litre or length overhead concealed SCIO supplied by contractor installed by owner FRR fire resisitance rating SCWD | solid core wood BKHD bulkhead cylinder LAB laboratory OPNG opening vinyl sheet flooring FRTR | fire retardant treated BLDG building LAM laminate OPP opposite SD soap dispenser vinyl wall covering SEAL sealant dead bolt fire separation lay-in acoustic panel outside visitor bike parking double OSB oriented strand board SECT section BLL bottom lower layer door contact OWSJ open web steel joist SEF seamless epoxy flooring BLT-IN built-in double catch basin FUT future SFPRG | sprayed fireproofing whiteboard lag bolt SIM similar BM bench mark public address decrease water closet GA gauge BOC bottom of curb light emitting diode precast concrete SLD sealed wood department BOH back of house detail GAL gallon light fixture SM surface mount WDB wood base porcelain ceramic tile GALV galvanized SND sanitary napkin dispenser WD PNL | wood panel bottom drinking fountain left hand porcelain enamel PEP porcelain eneamel panel brick door hardware GB grab bar LHR left hand reverse SNR sanitary napkin receptacle WDV wood veneer SP soundproof bronze diameter general contractor linoleum wire guard BSMT basement diagonal GEN general live load PERF perforated SPEC specification within built-up glazing film locking ladder pull pre finished BUL bottom upper layer GFI ground fault interrupted long leg vertical property line SS stainless steel BUR built-up roofing dead load LOC PLAM plastic laminate SSM solid surface material galvanized iron waterproof down PLY plywood ST stain GL glass waterproofing low point GLZ glazing film STL steel WPM water proof membrane door operator ladder pull GOVT government deep polished STN stone laguer water resistant P/P STD standard damper GR grade loud speaker push/pull water stop STOR storage GRAN granular waterproof traffic surfacing lever handle STRUCT structural WVNR door stop GRD ground light weight PRI primary wood veneer door undercut light weight block writable wall covering GWB gypsum wall board barrier free push to lock GWC graphic wall covering PTN partition GWG georgian wired glass










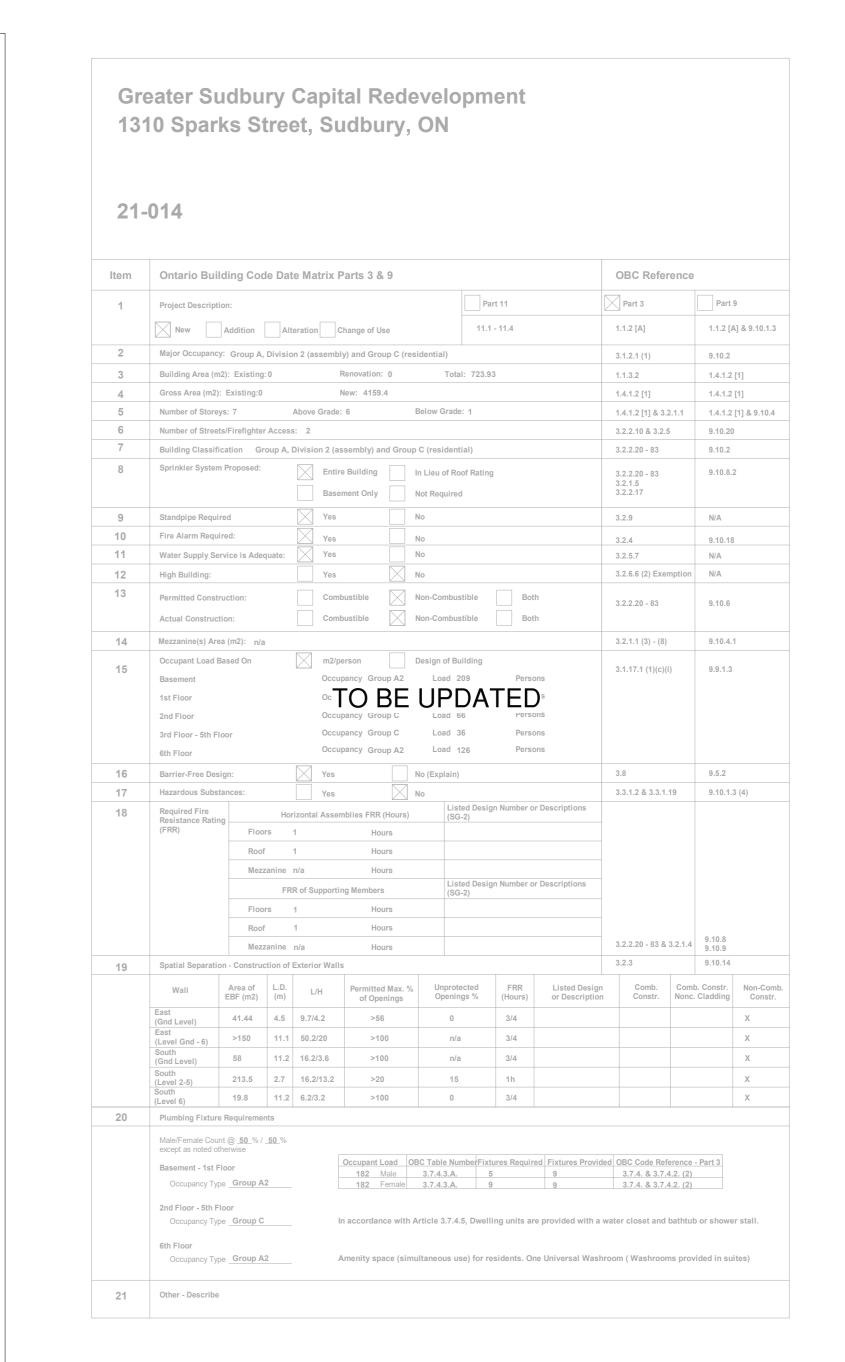

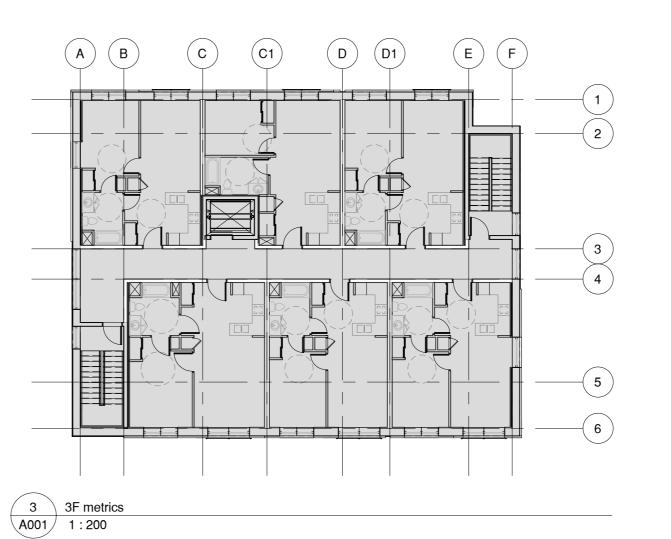

Ground Floor - 372 m²


Second Floor - 426 m²

Third Floor - 426 m²

TOTAL FLOOR AREA: 1224 m² / 13175 sq.ft

SITE LOCATION

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Toronto, Ontario, M6K 3E7

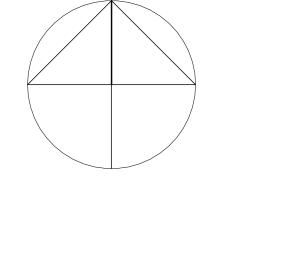T 416.536.5666 F 416.536.8626

The General Contractor shall check and verify all dimensions and report all

errors and ommisions. Do not scale drawings. These documents shall only

be used for the purpose indicated below, when as noted and initiated by the


Certificate of Practice No.:

1 Issued for Rezoning

Architect's BCIN:

JONATHAN M. KEARNS

LICENCE 3064

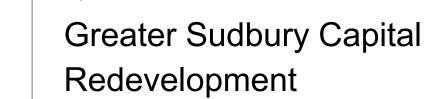


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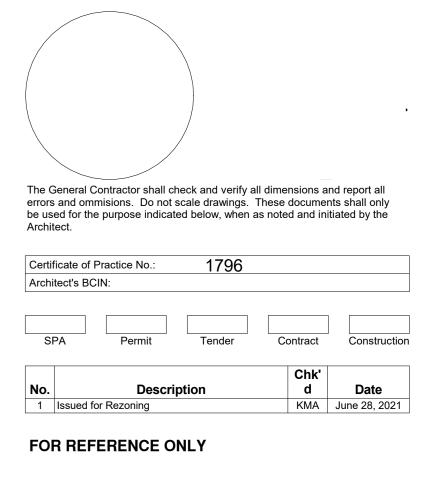
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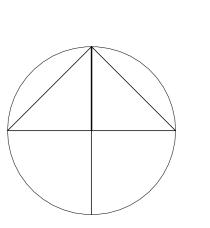
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Drawing No. **Project Information**







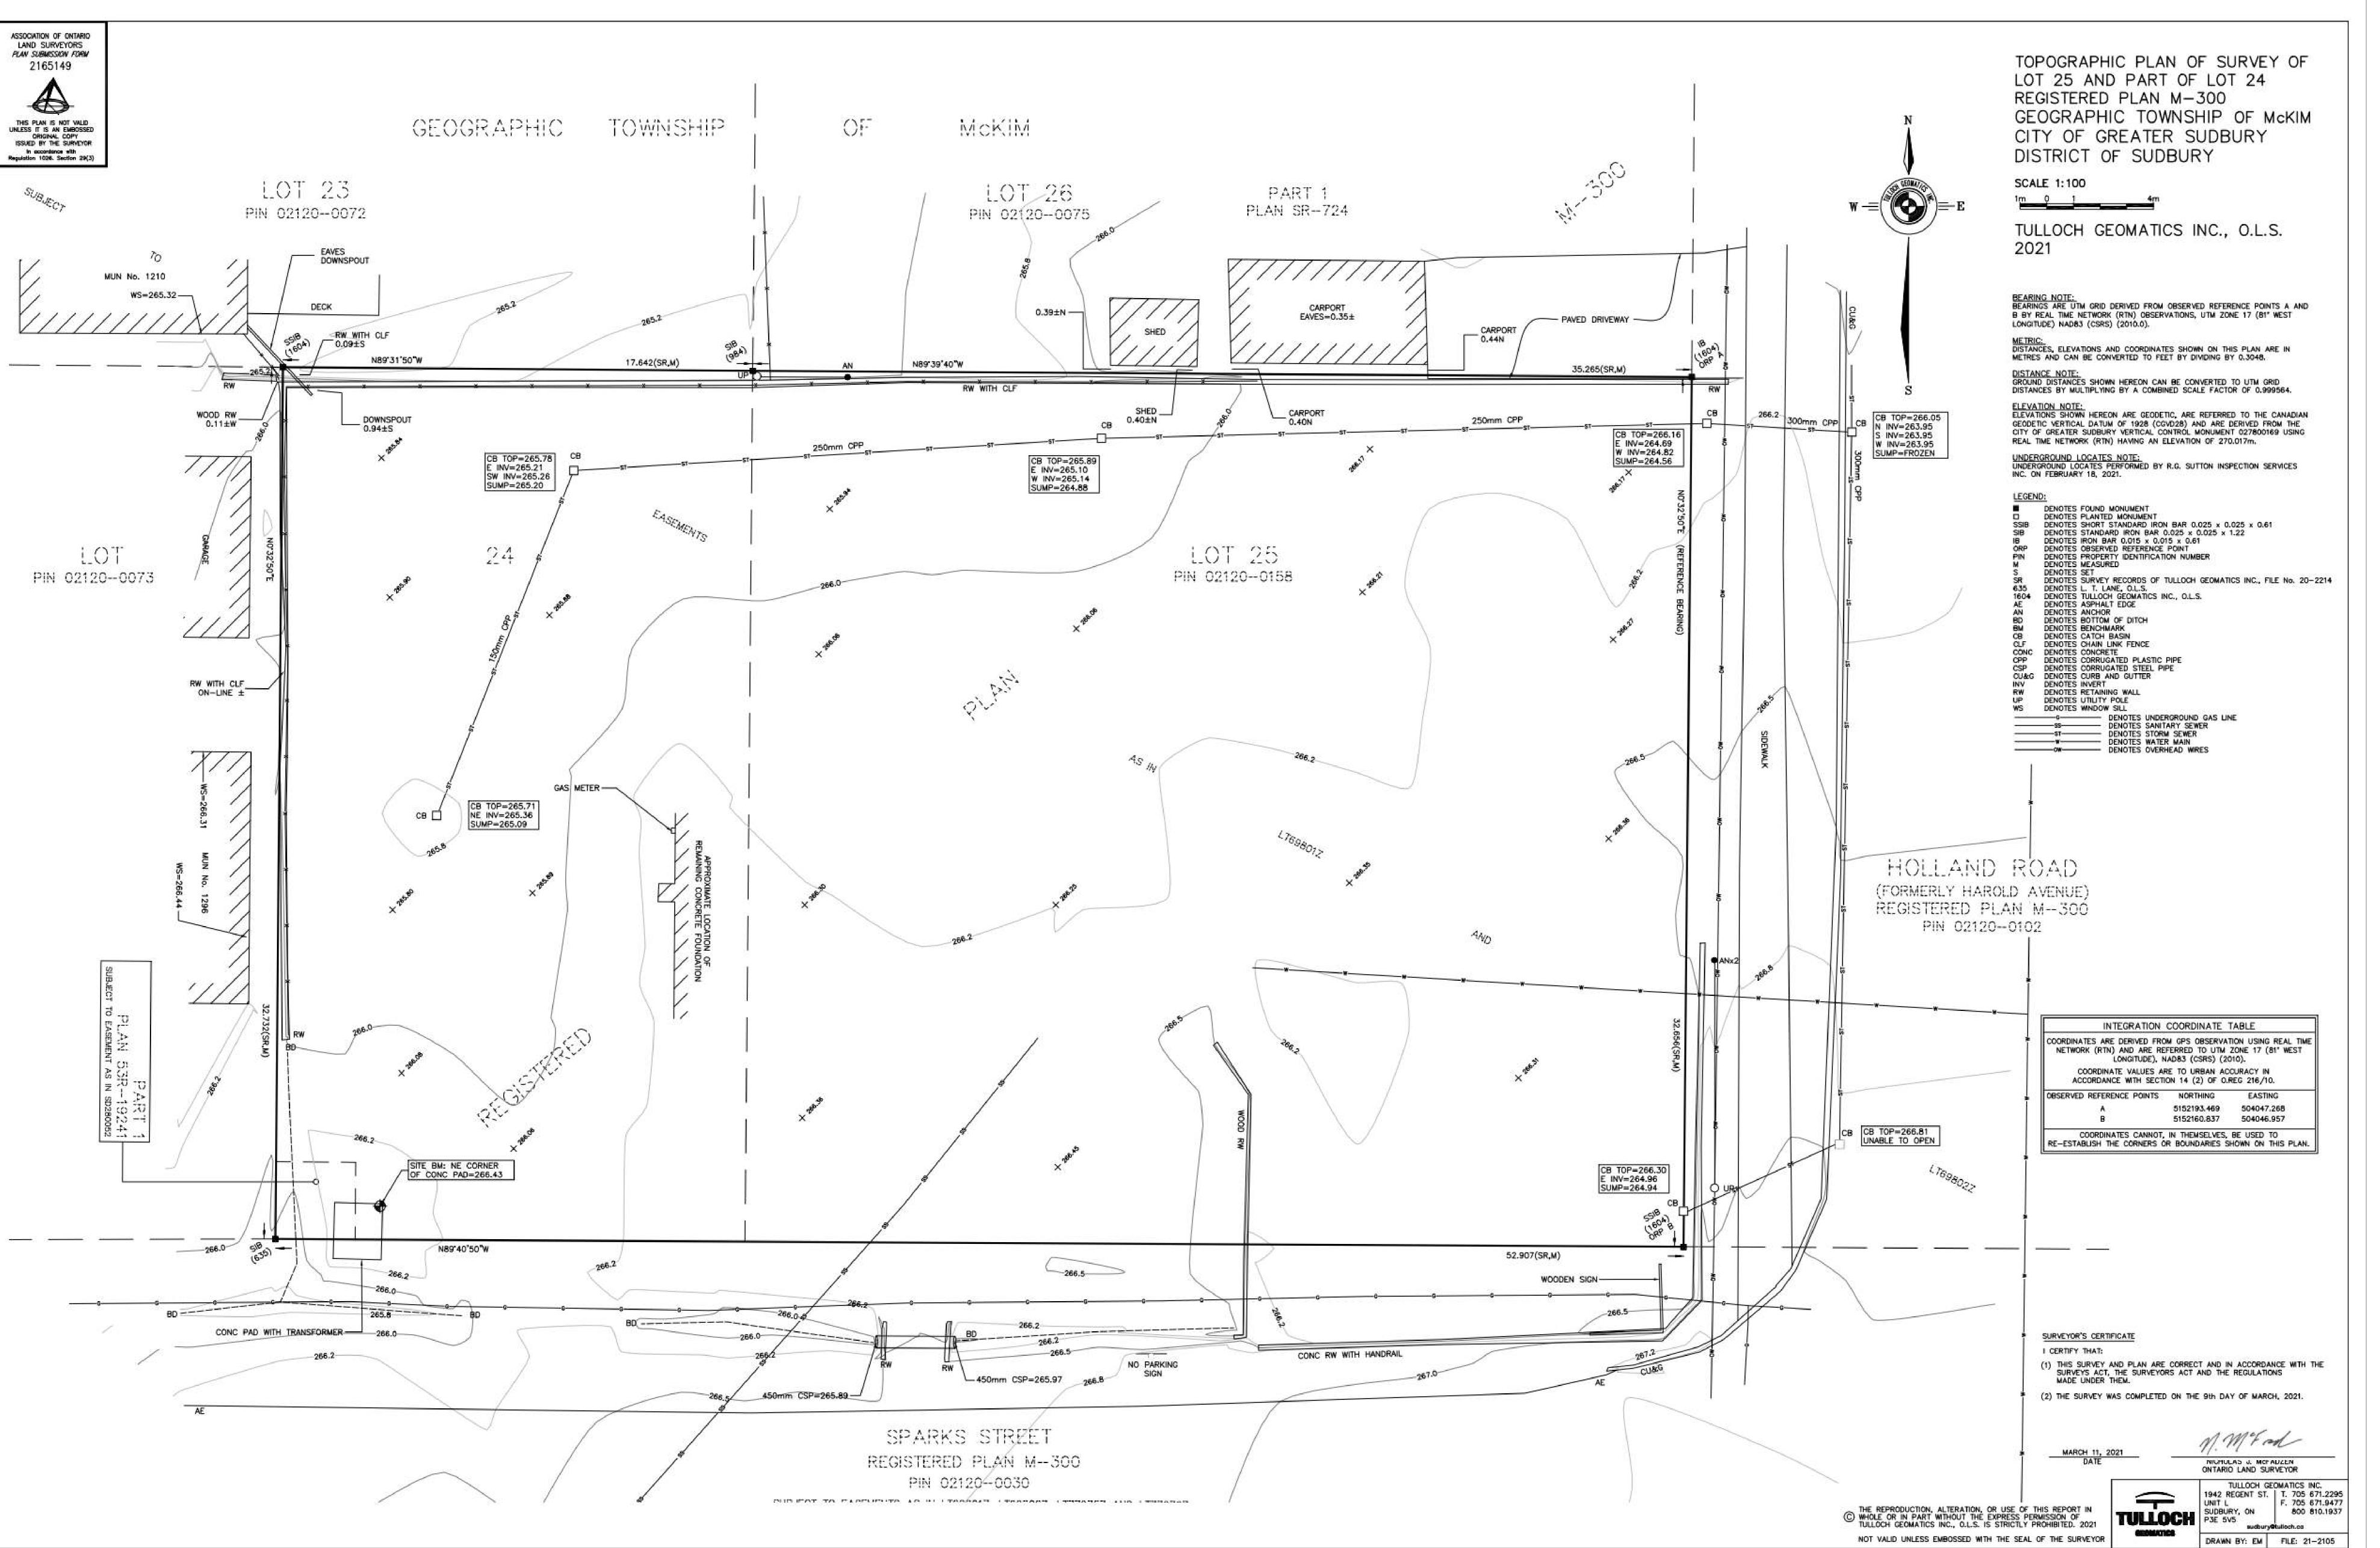

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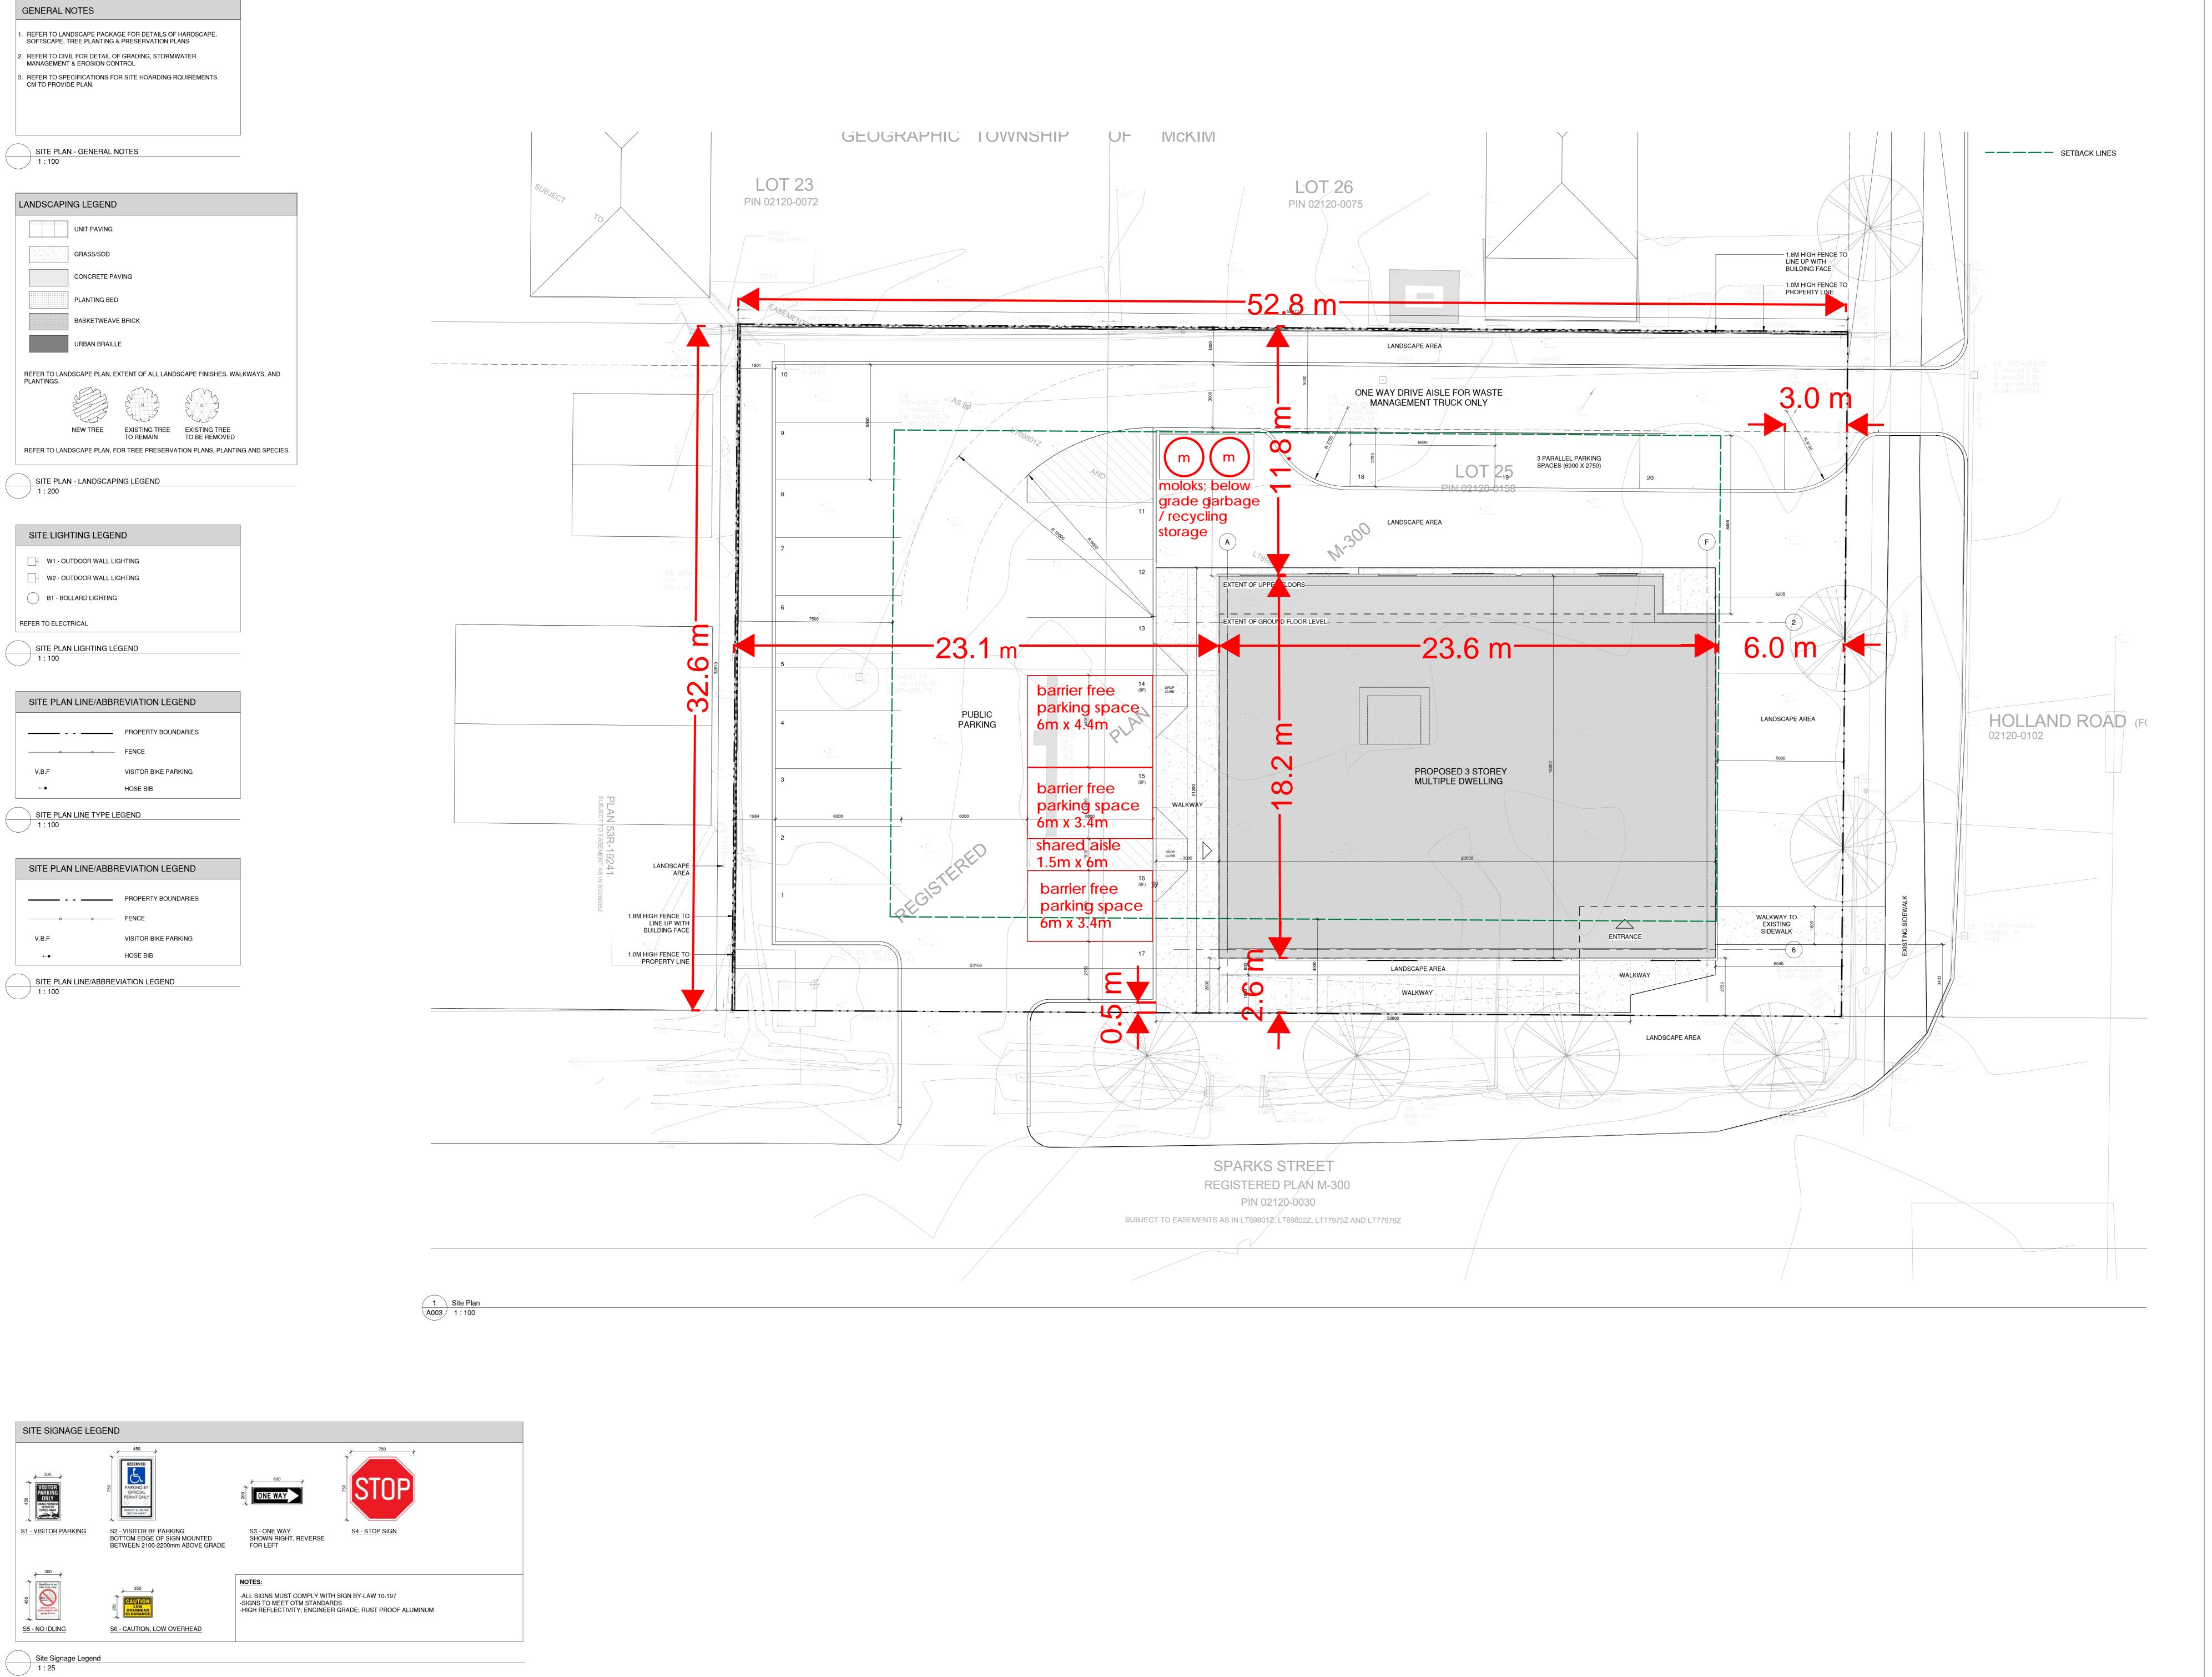
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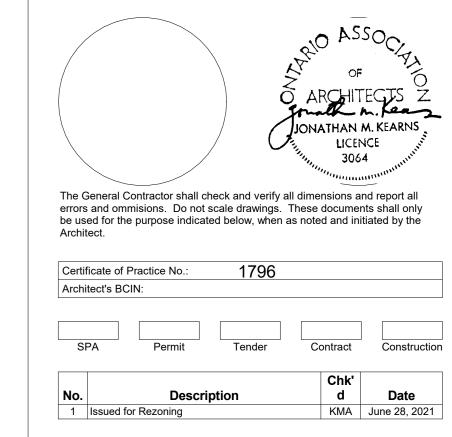
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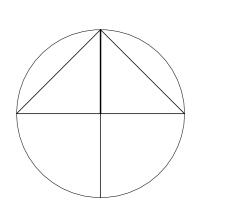
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Site Survey









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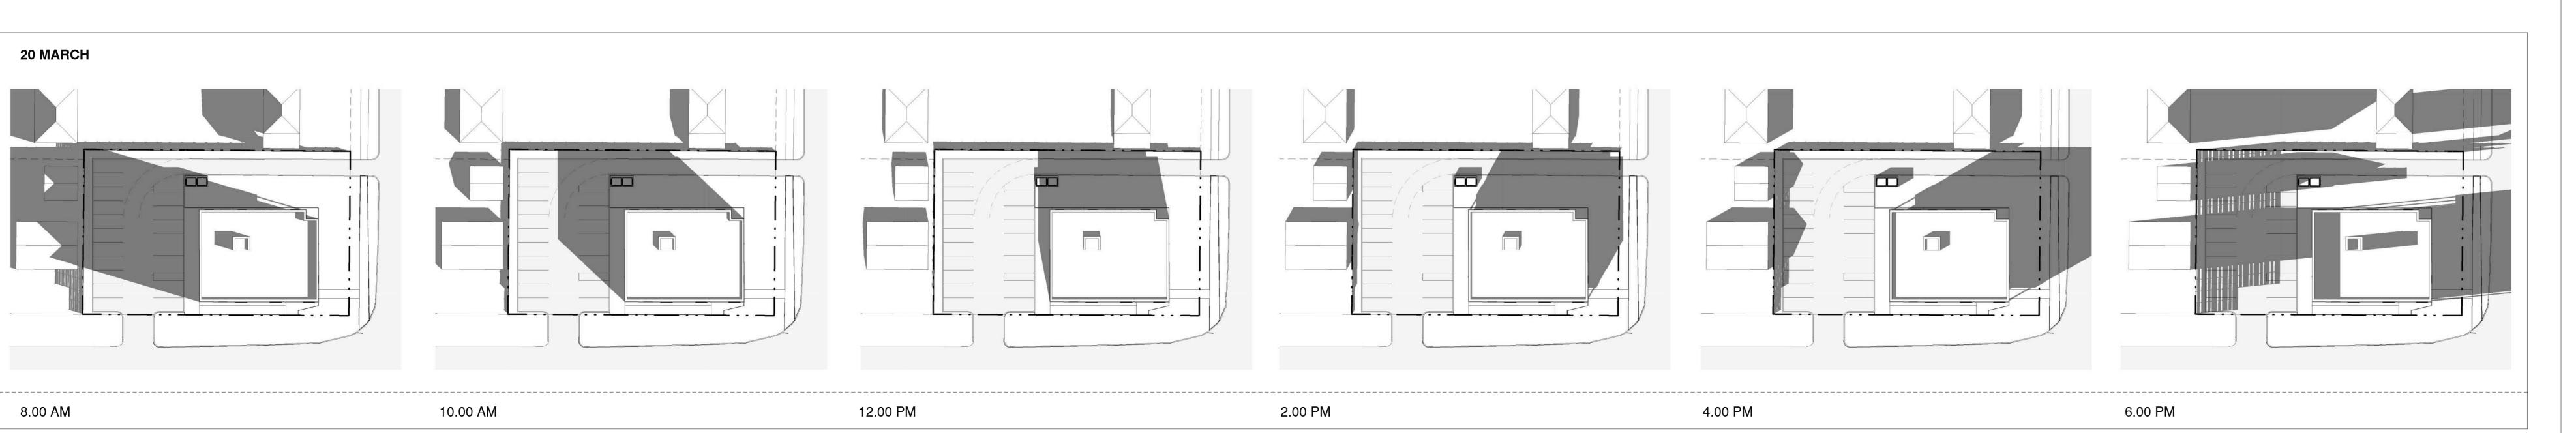
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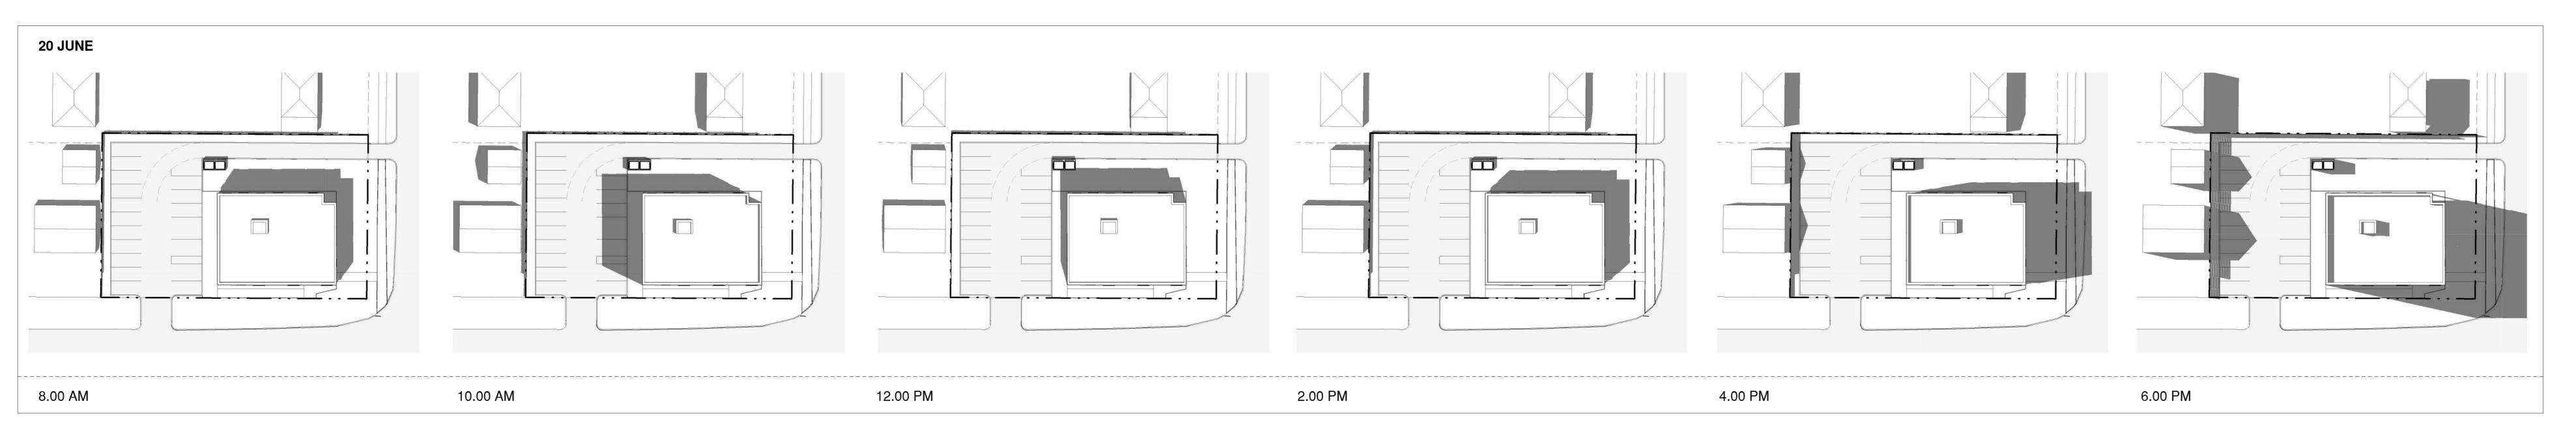
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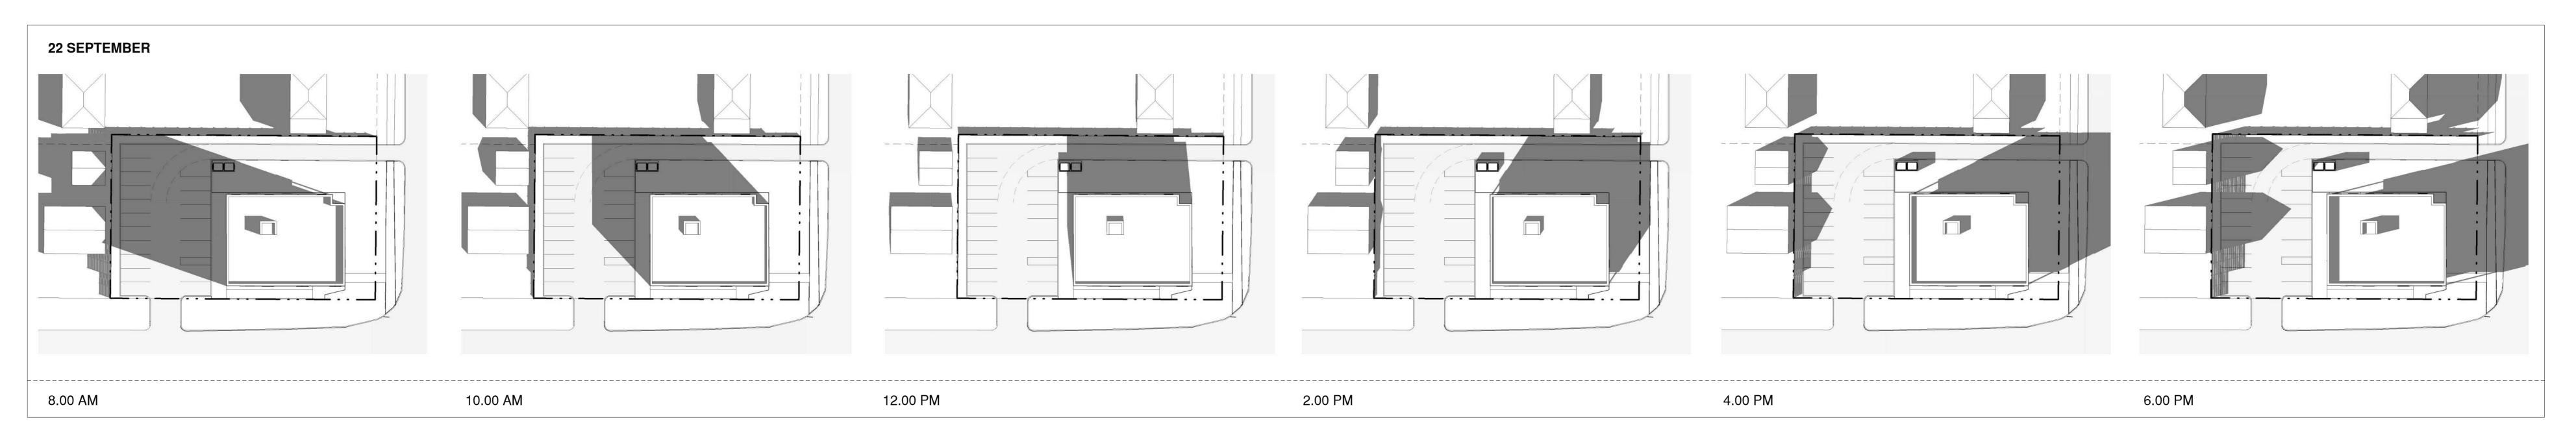
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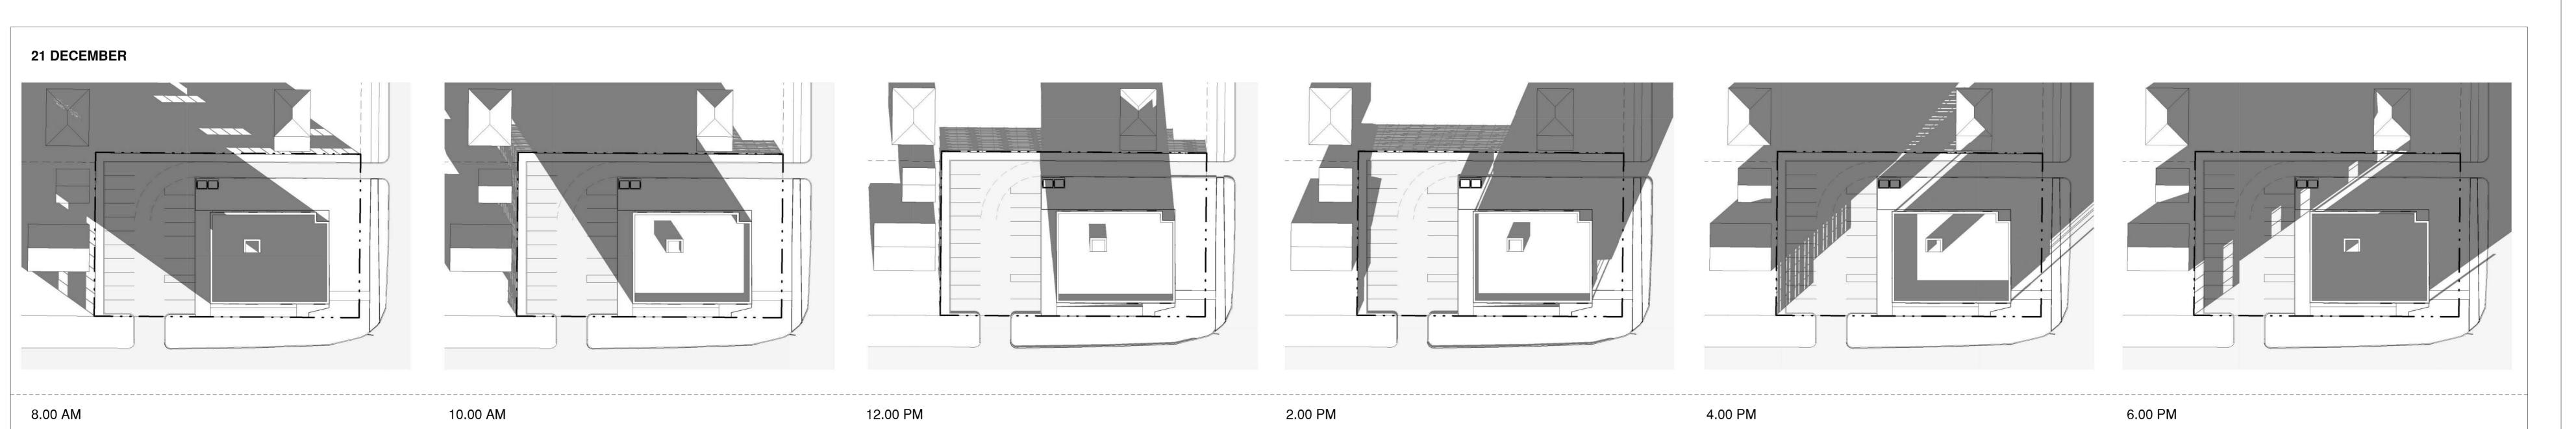
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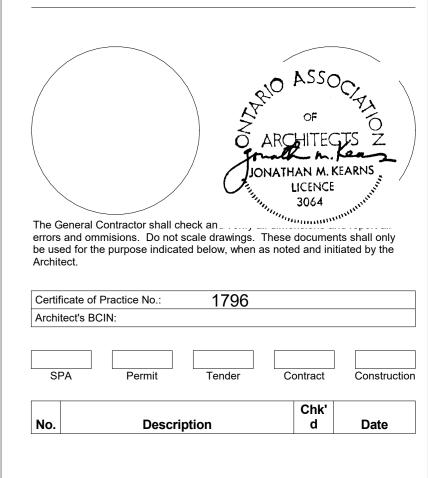













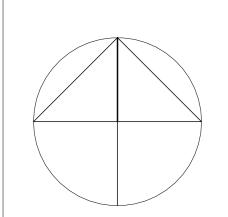

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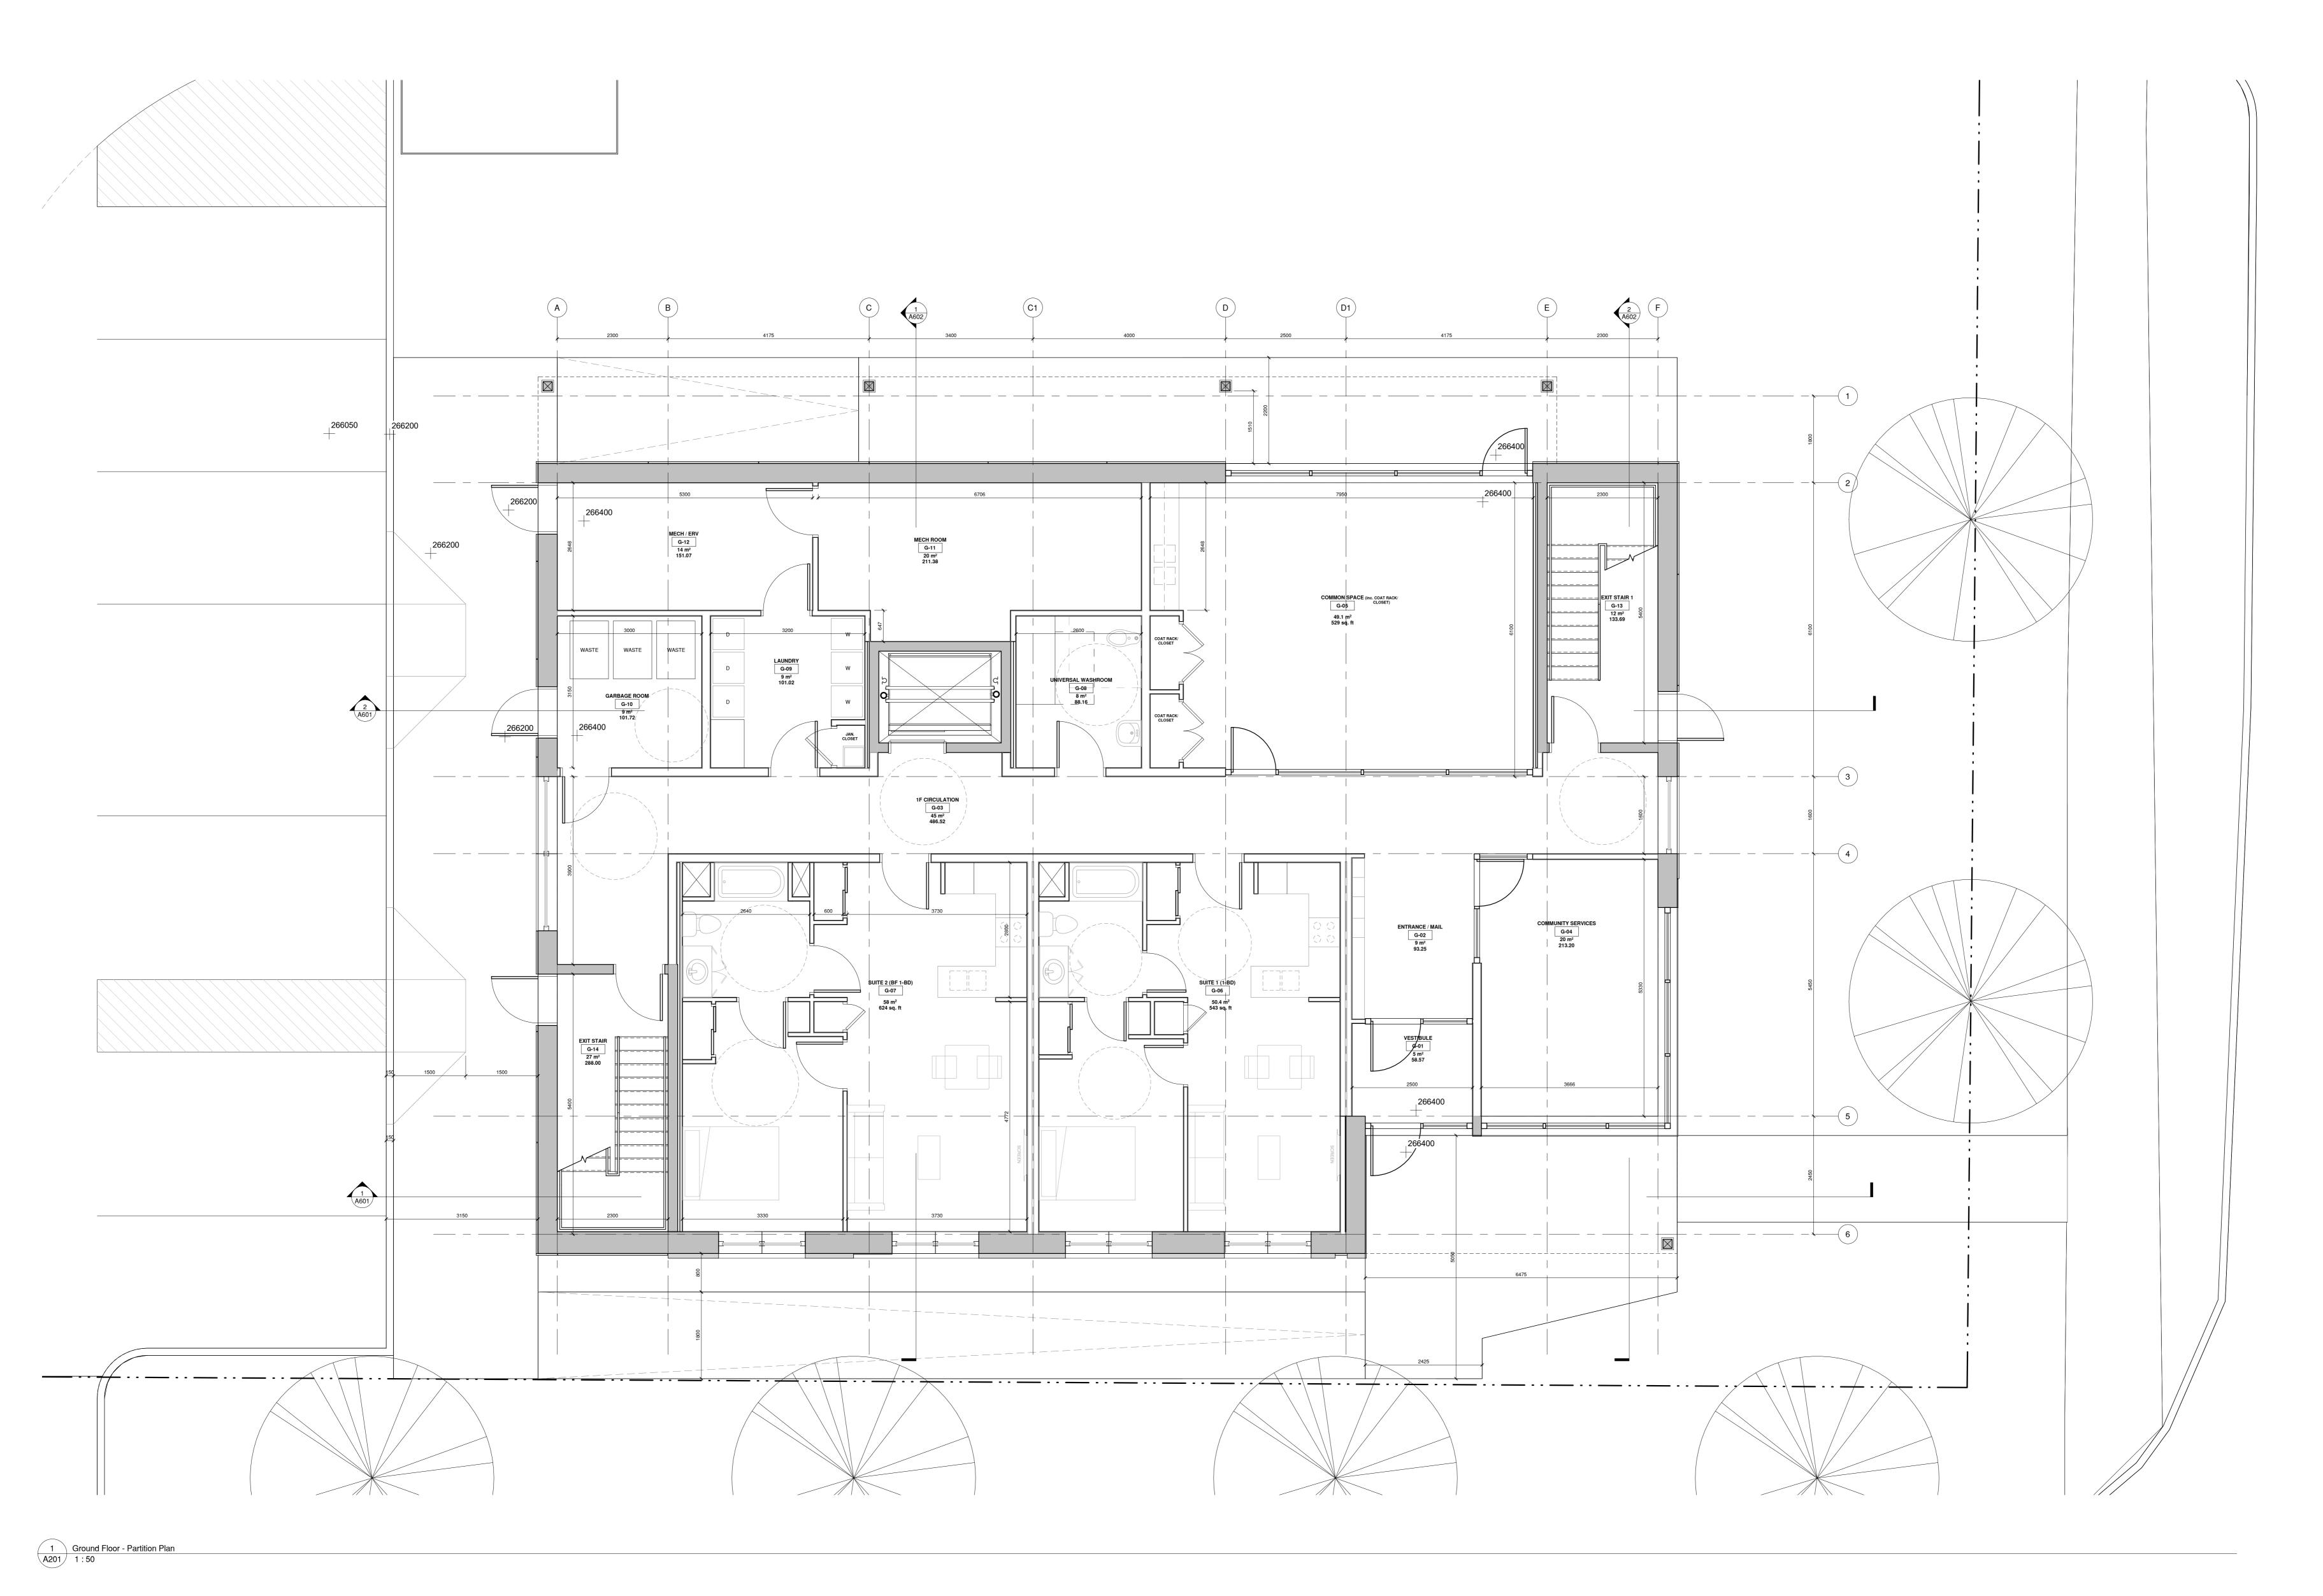
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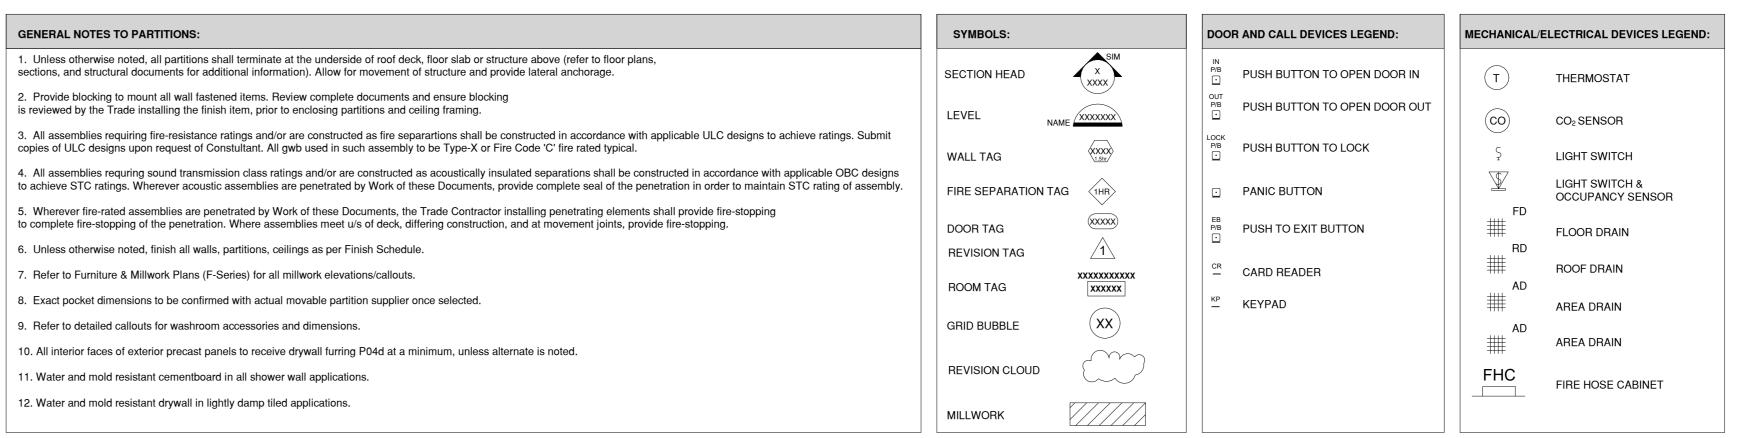
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Shadow Study

4010







General Partition Notes
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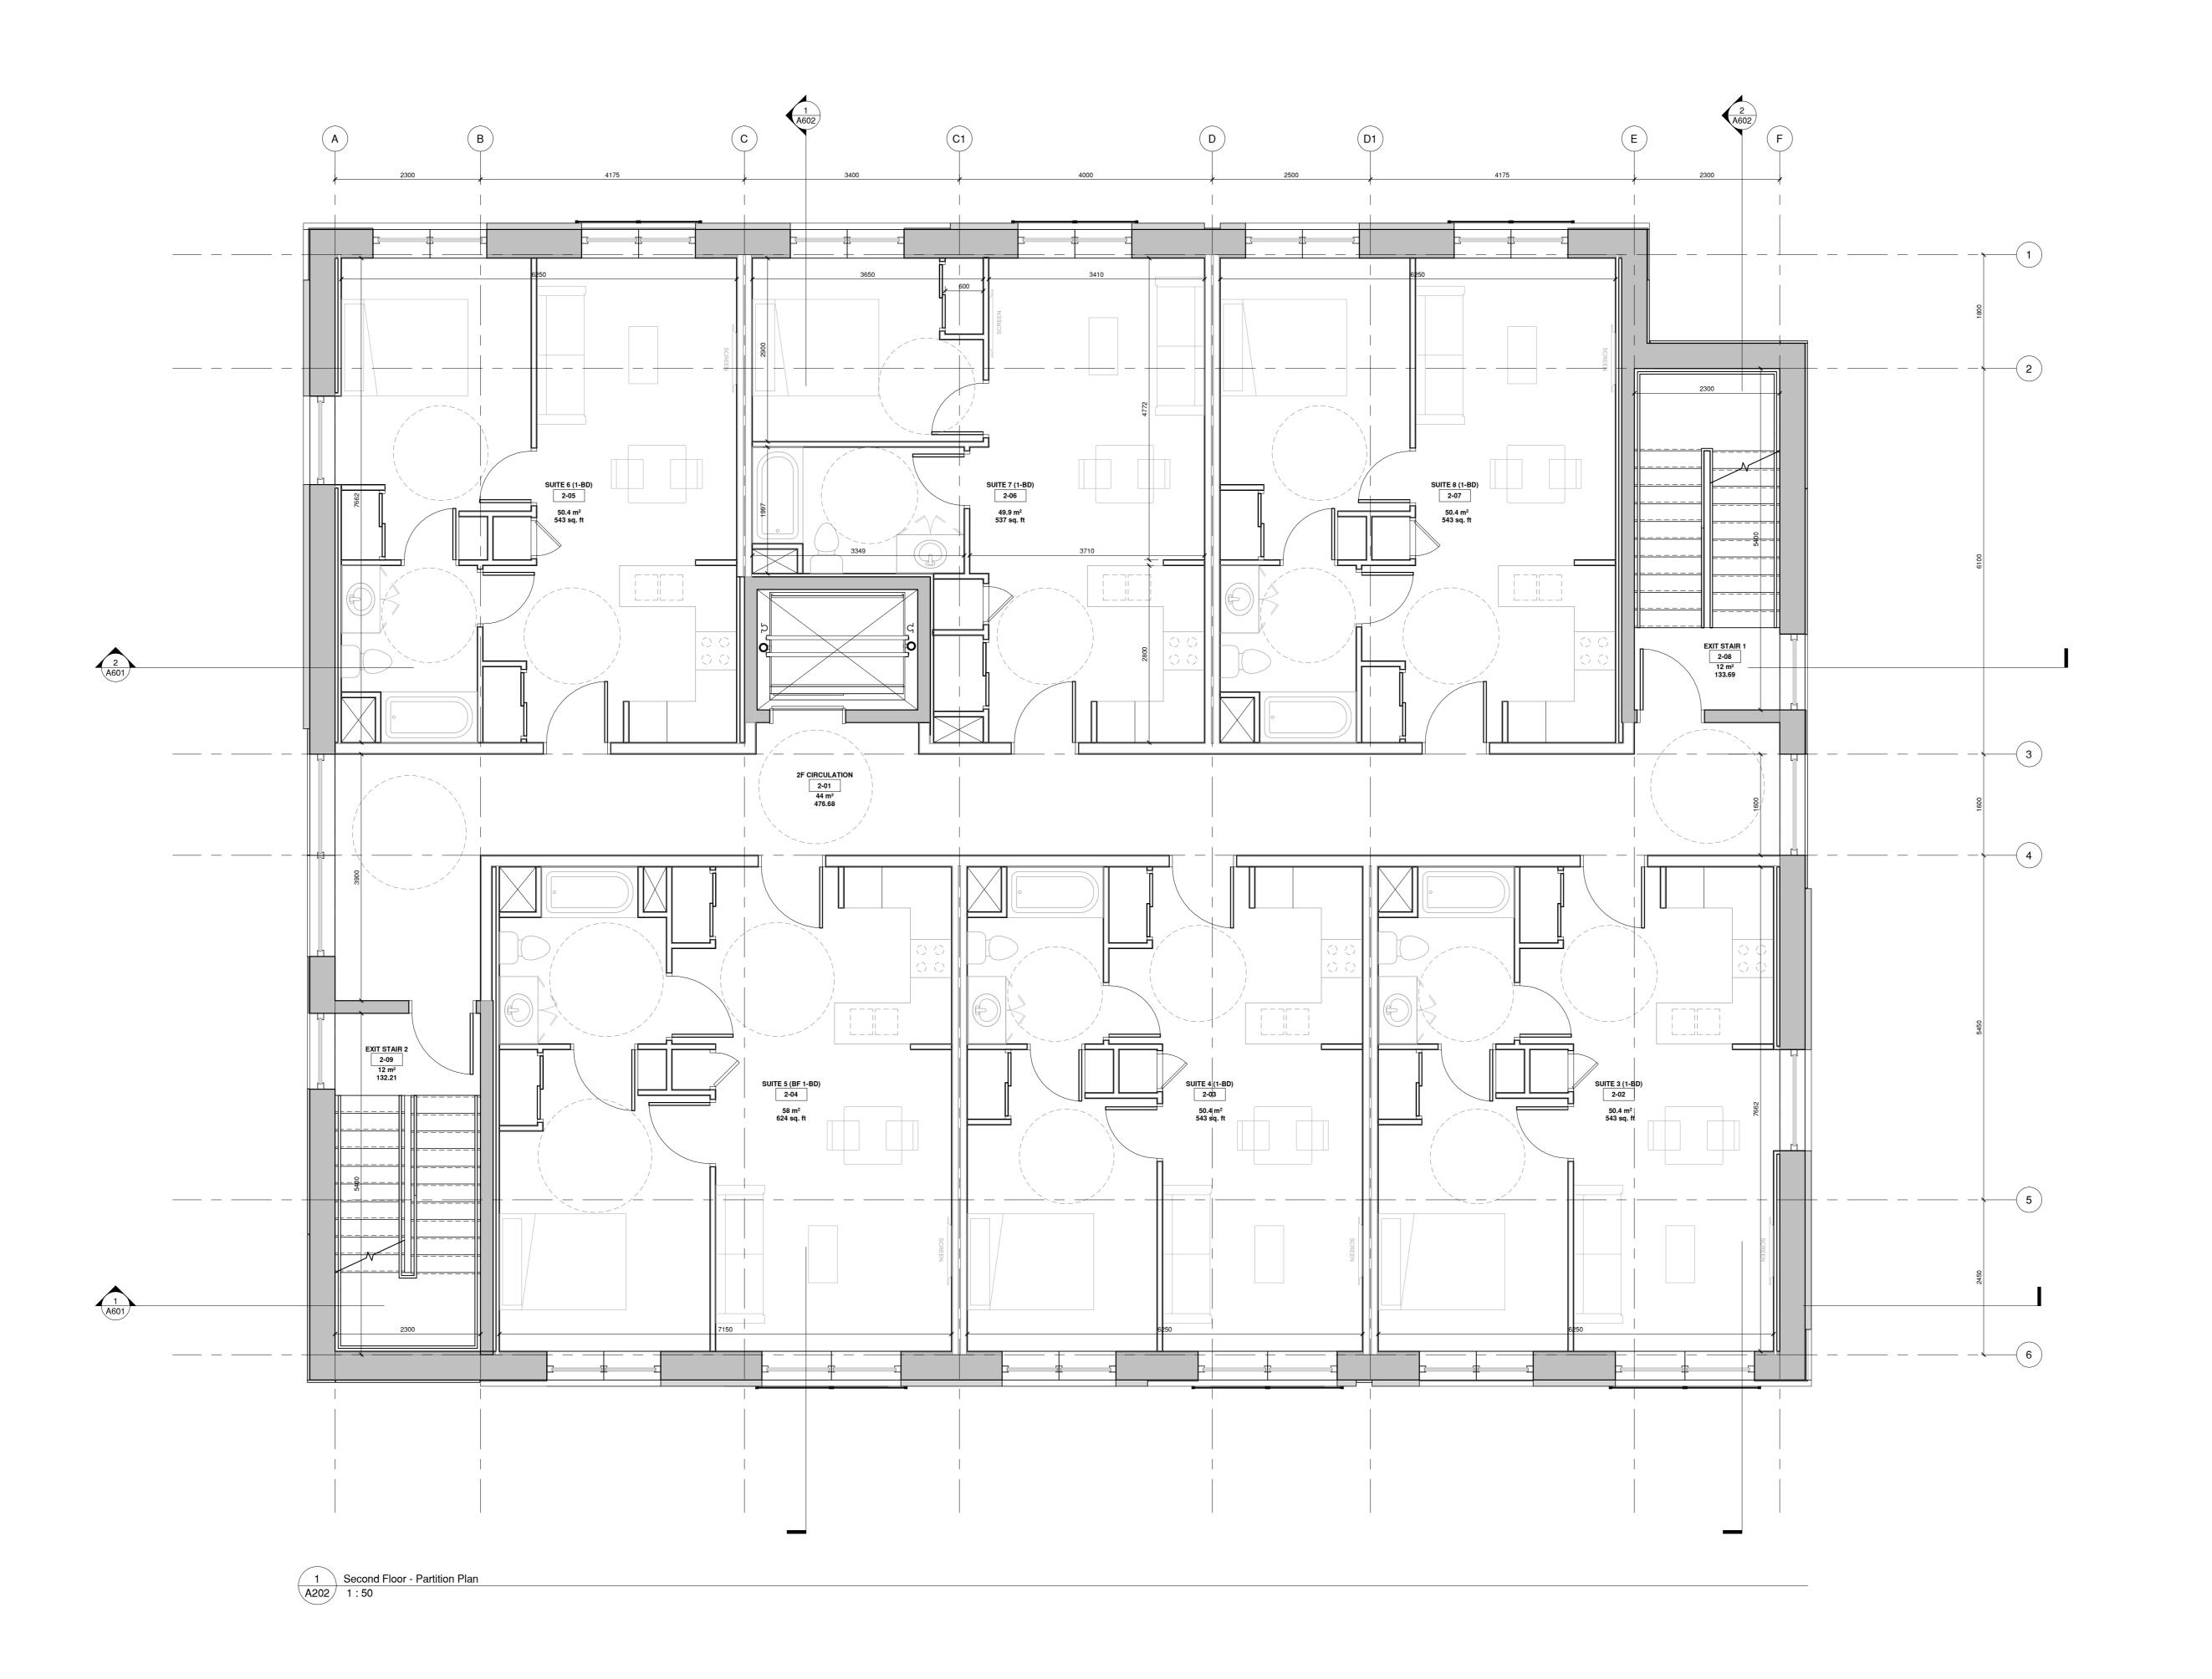
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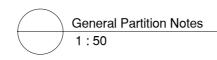
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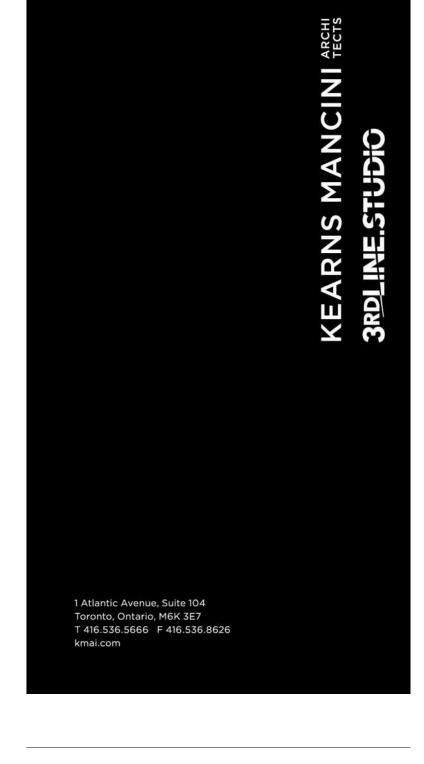
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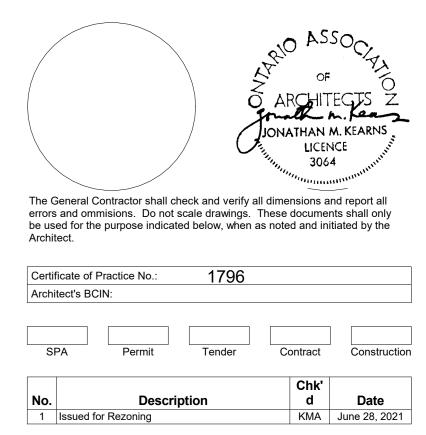
Ground Floor Plan




GENERAL NOTES TO PARTITIONS:	SYMBOLS:	DOOR AND CALL DEVICES LEGEND:	MECHANICAL/ELECTRICAL DEVICES LEGEND:
. Unless otherwise noted, all partitions shall terminate at the underside of roof deck, floor slab or structure above (refer to floor plans, ections, and structural documents for additional information). Allow for movement of structure and provide lateral anchorage.	SECTION HEAD XXXXX	IN PUSH BUTTON TO OPEN DOOR IN	T THERMOSTAT
t. Provide blocking to mount all wall fastened items. Review complete documents and ensure blocking serviewed by the Trade installing the finish item, prior to enclosing partitions and ceiling framing.	LEVEL NAME XXXXXXXX	OUT P/B PUSH BUTTON TO OPEN DOOR OUT	(CO) CO₂ SENSOR
All assemblies requiring fire-resistance ratings and/or are constructed as fire separartions shall be constructed in accordance with applicable ULC designs to achieve ratings. Submit opies of ULC designs upon request of Constultant. All gwb used in such assembly to be Type-X or Fire Code 'C' fire rated typical.	WALL TAG	PIB PUSH BUTTON TO LOCK	Ş LIGHT SWITCH
All assemblies requring sound transmission class ratings and/or are constructed as acoustically insulated separations shall be constructed in accordance with applicable OBC designs achieve STC ratings. Wherever acoustic assemblies are penetrated by Work of these Documents, provide complete seal of the penetration in order to maintain STC rating of assembly.	FIRE SEPARATION TAG (1HR)	☐ PANIC BUTTON	LIGHT SWITCH & OCCUPANCY SENSOR
Wherever fire-rated assemblies are penetrated by Work of these Documents, the Trade Contractor installing penetrating elements shall provide fire-stopping of the penetration. Where assemblies meet u/s of deck, differing construction, and at movement joints, provide fire-stopping.	DOOR TAG (XXXXX)	EB P/B PUSH TO EXIT BUTTON	FD ## FLOOR DRAIN
5. Unless otherwise noted, finish all walls, partitions, ceilings as per Finish Schedule.	REVISION TAG		RD ###
7. Refer to Furniture & Millwork Plans (F-Series) for all millwork elevations/callouts.	ROOM TAG XXXXXXXXX	CR CARD READER	ROOF DRAIN
Exact pocket dimensions to be confirmed with actual movable partition supplier once selected.	ROOM TAG XXXXXXX	KP KEYPAD	# AREA DRAIN
. Refer to detailed callouts for washroom accessories and dimensions.	GRID BUBBLE XX		AD
0. All interior faces of exterior precast panels to receive drywall furring P04d at a minimum, unless alternate is noted.			## AREA DRAIN
Water and mold resistant cementboard in all shower wall applications.	REVISION CLOUD		FHC FIRE HOSE CABINET
2. Water and mold resistant drywall in lightly damp tiled applications.	MILLWORK		

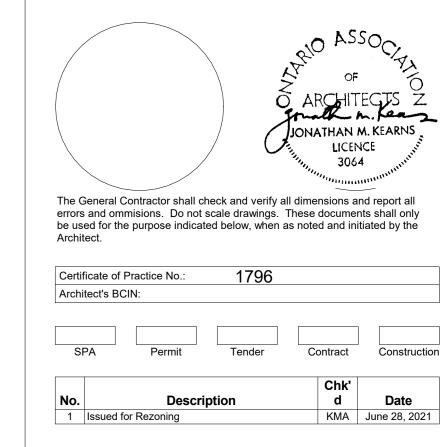

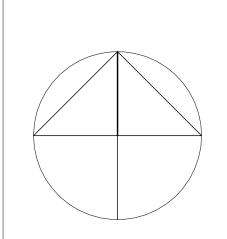




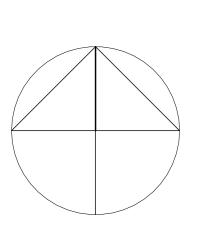


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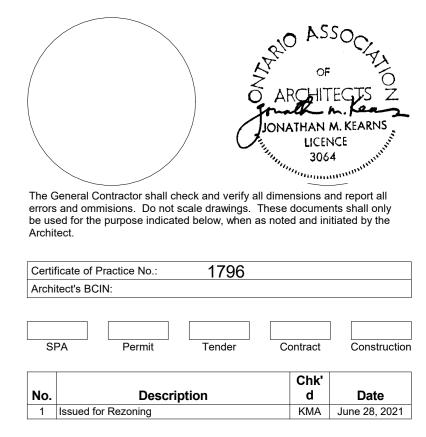
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		Level 2 Plan




GENERAL NOTES TO PARTITIONS:	SYMBOLS:	DOOR AND CALL DEVICES LEGEND:	MECHANICAL/ELECTRICAL DEVICES LEGEND:
Unless otherwise noted, all partitions shall terminate at the underside of roof deck, floor slab or structure above (refer to floor plans, sections, and structural documents for additional information). Allow for movement of structure and provide lateral anchorage.	SECTION HEAD XXXXX	IN P/B PUSH BUTTON TO OPEN DOOR IN	(T) THERMOSTAT
2. Provide blocking to mount all wall fastened items. Review complete documents and ensure blocking is reviewed by the Trade installing the finish item, prior to enclosing partitions and ceiling framing.	LEVEL NAME XXXXXXX	OUT P/B PUSH BUTTON TO OPEN DOOR OUT	(CO) CO₂ SENSOR
3. All assemblies requiring fire-resistance ratings and/or are constructed as fire separartions shall be constructed in accordance with applicable ULC designs to achieve ratings. Submit copies of ULC designs upon request of Constultant. All gwb used in such assembly to be Type-X or Fire Code 'C' fire rated typical.	WALL TAG	LOCK PPB PUSH BUTTON TO LOCK	Ş LIGHT SWITCH
4. All assemblies requring sound transmission class ratings and/or are constructed as acoustically insulated separations shall be constructed in accordance with applicable OBC designs to achieve STC ratings. Wherever acoustic assemblies are penetrated by Work of these Documents, provide complete seal of the penetration in order to maintain STC rating of assembly.	FIRE SEPARATION TAG (1HR)	□ PANIC BUTTON	LIGHT SWITCH & OCCUPANCY SENSOR
5. Wherever fire-rated assemblies are penetrated by Work of these Documents, the Trade Contractor installing penetrating elements shall provide fire-stopping o complete fire-stopping of the penetration. Where assemblies meet u/s of deck, differing construction, and at movement joints, provide fire-stopping.	DOOR TAG	EB P/B PUSH TO EXIT BUTTON	FD ## FLOOR DRAIN
6. Unless otherwise noted, finish all walls, partitions, ceilings as per Finish Schedule.	REVISION TAG 1		RD ROOF DRAIN
. Refer to Furniture & Millwork Plans (F-Series) for all millwork elevations/callouts.	ROOM TAG XXXXXXXXX	CR CARD READER	### ROOF DRAIN AD
3. Exact pocket dimensions to be confirmed with actual movable partition supplier once selected.	ROOM TAG XXXXXX	KP KEYPAD	# AREA DRAIN
Refer to detailed callouts for washroom accessories and dimensions.	GRID BUBBLE (XX)		AD
0. All interior faces of exterior precast panels to receive drywall furring P04d at a minimum, unless alternate is noted.			## AREA DRAIN
11. Water and mold resistant cementboard in all shower wall applications.	REVISION CLOUD		FHC FIRE HOSE CABINET
12. Water and mold resistant drywall in lightly damp tiled applications.	MILLWORK		

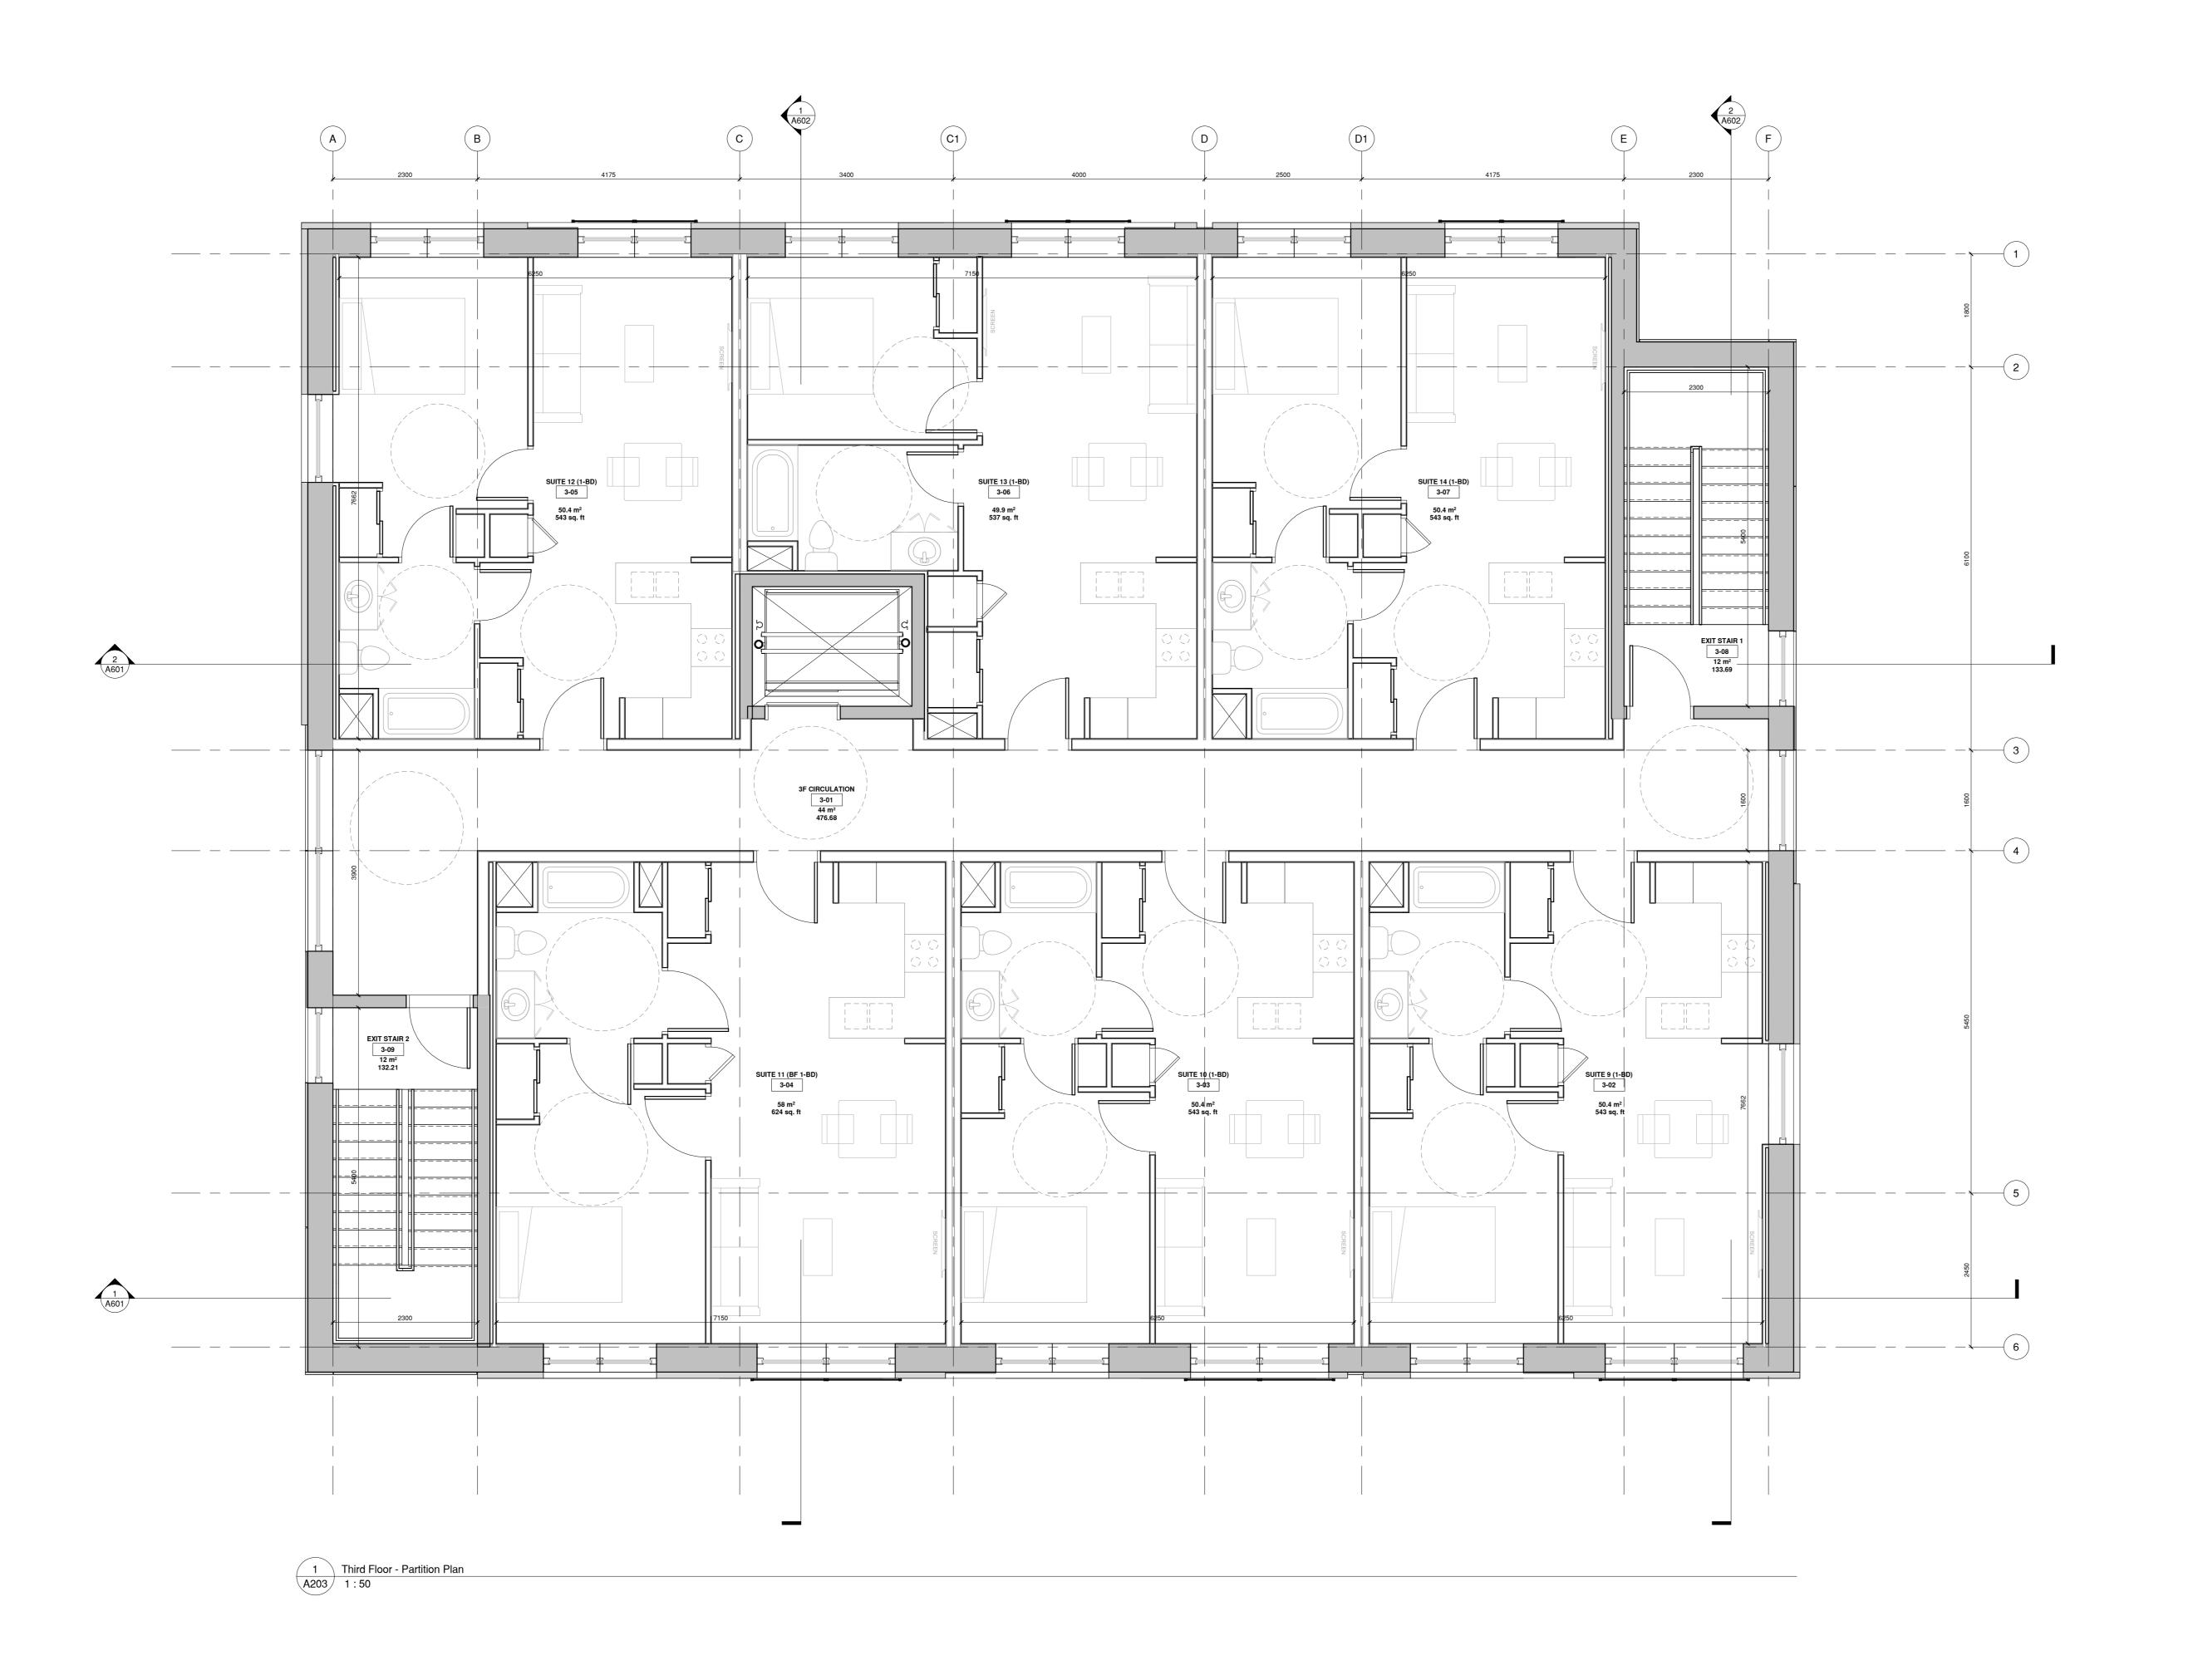



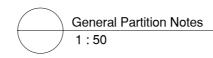

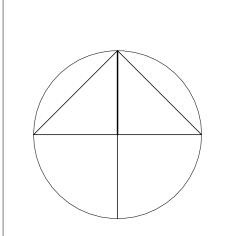



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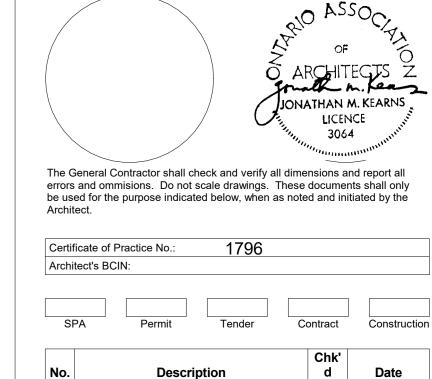
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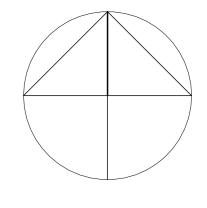
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Level 3 Plan







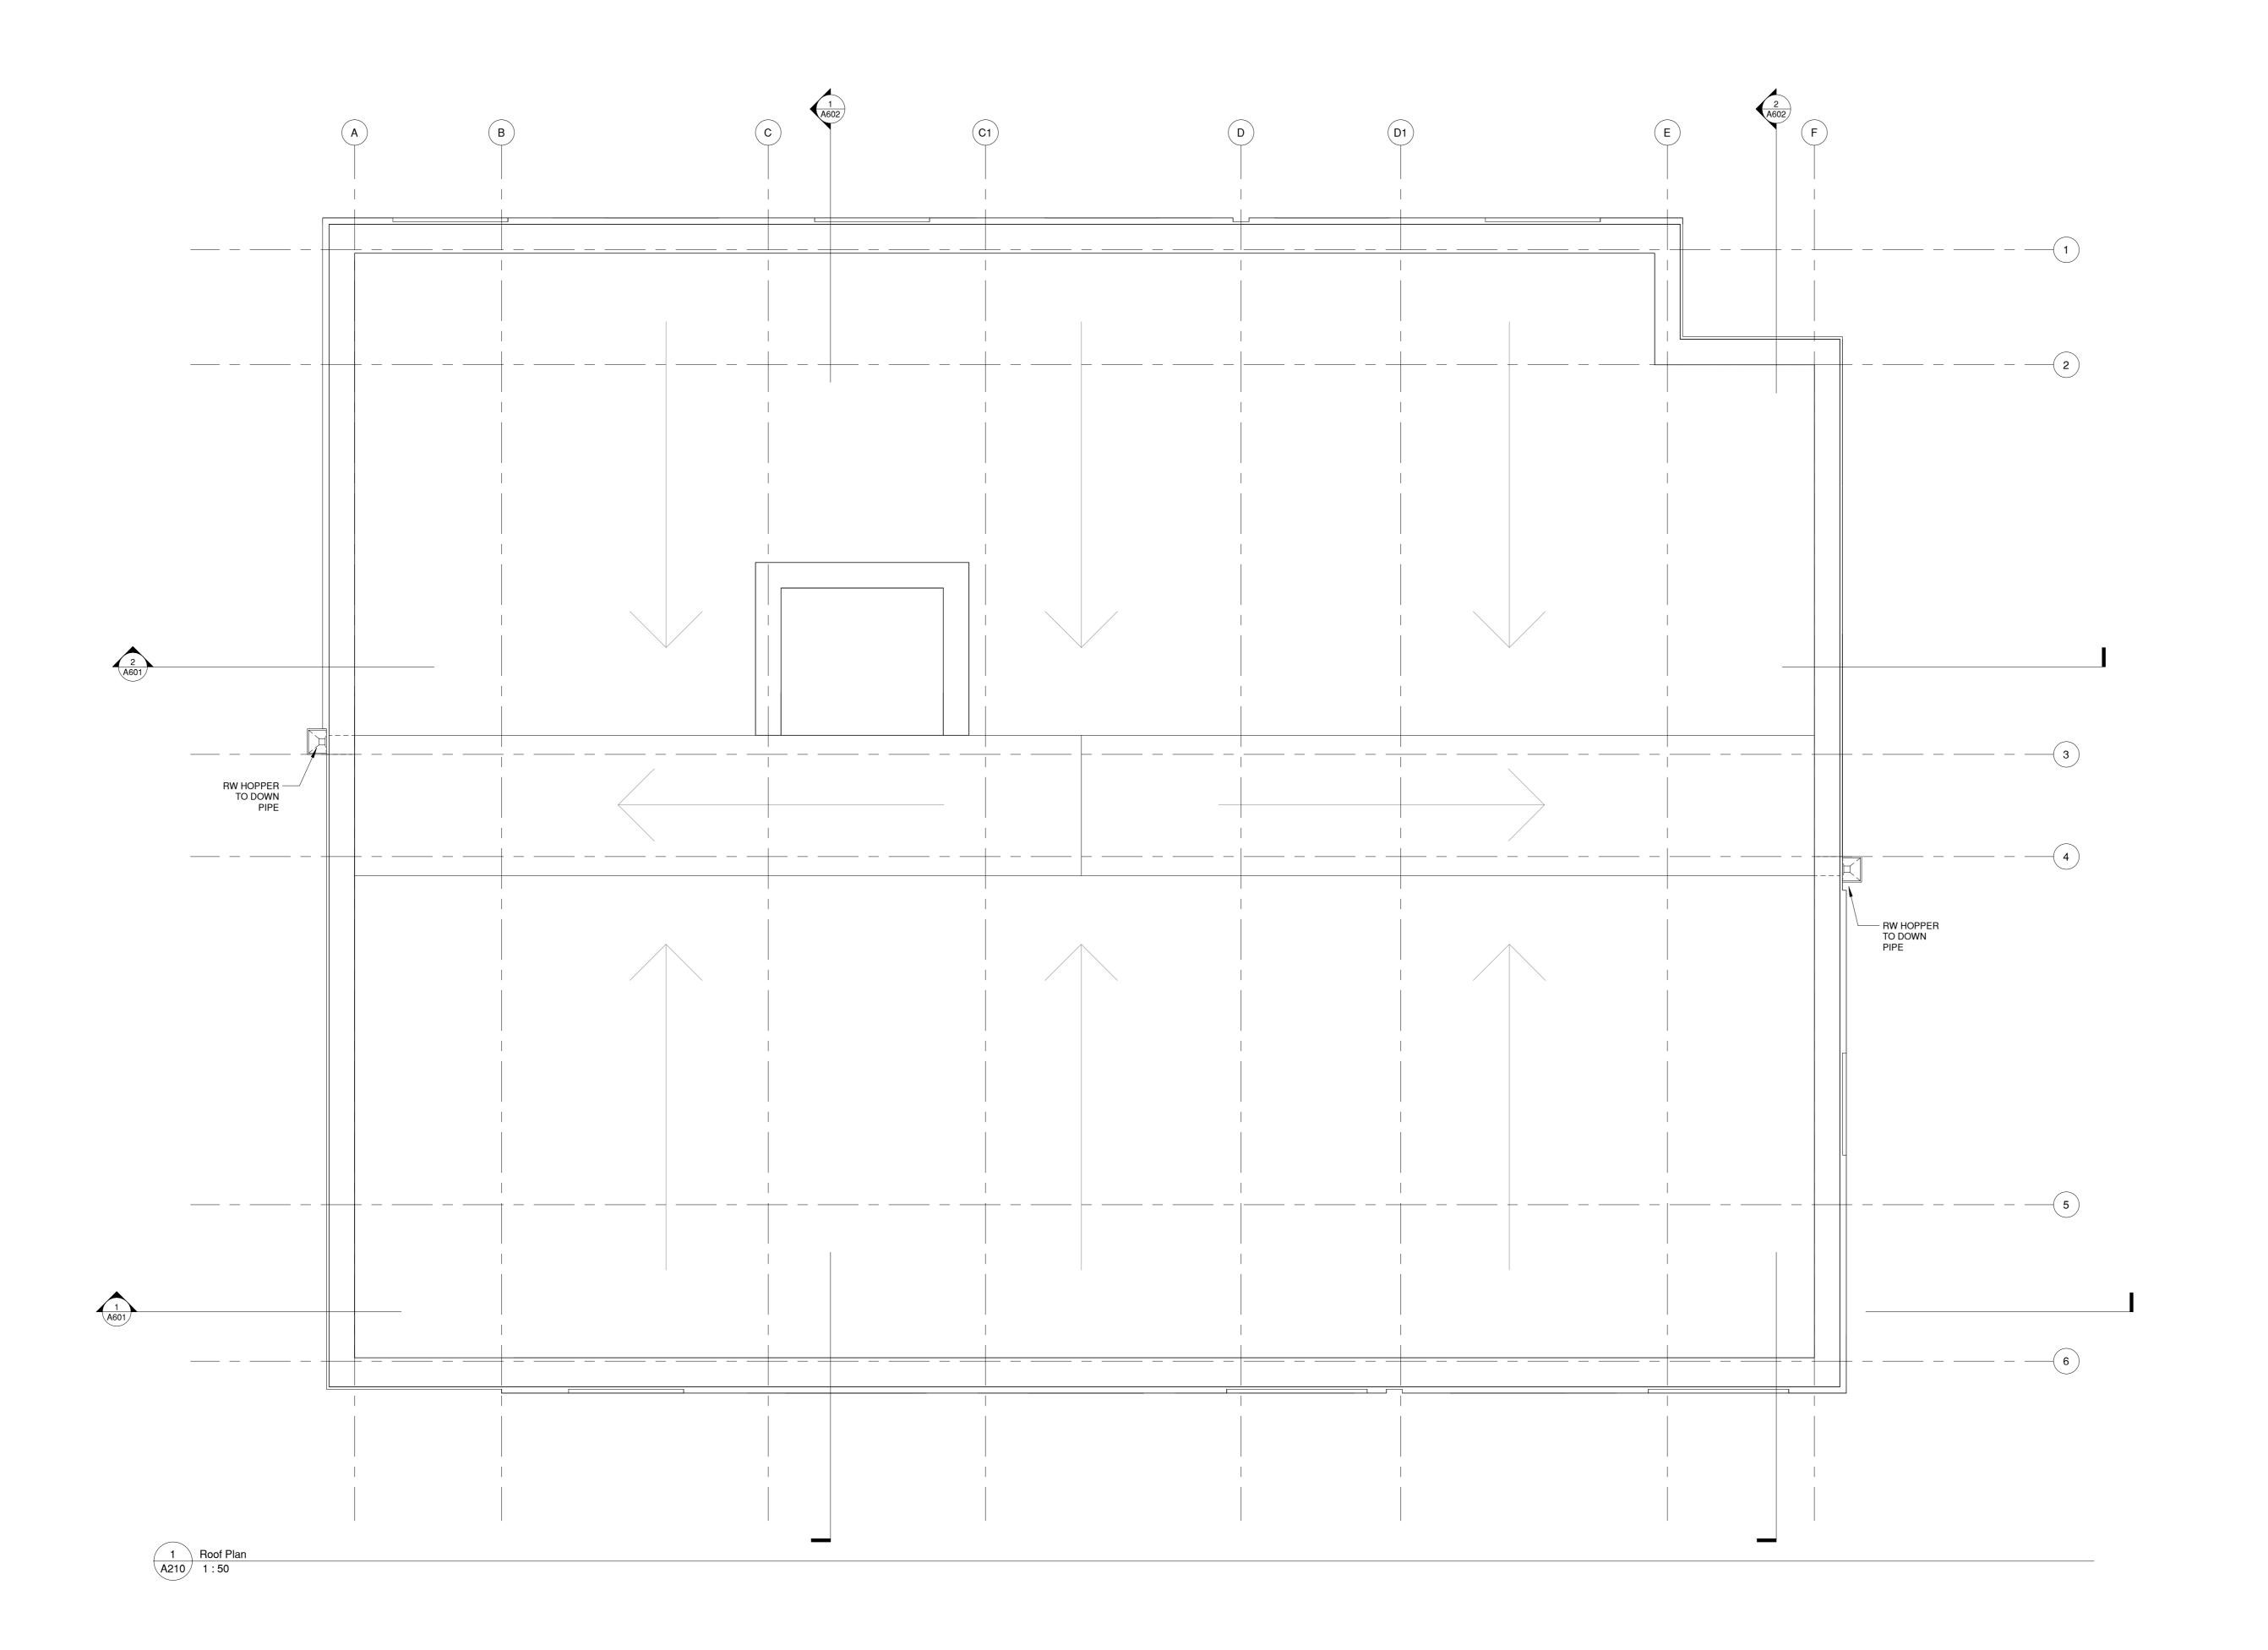
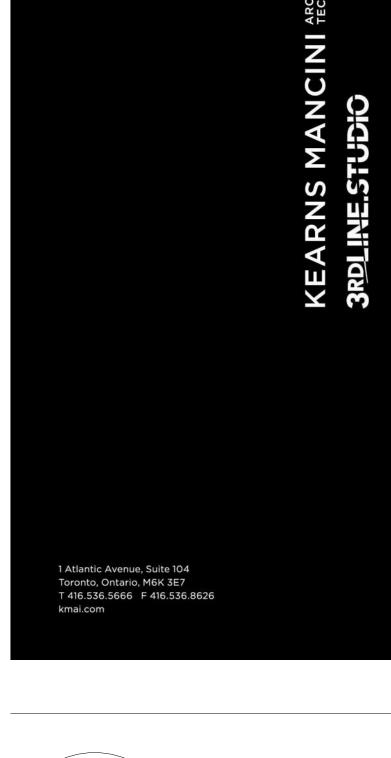
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21-014 Drawing No.


Roof Plan






EXTERIOR BUILD	ING MATEF	RIAL LEGEND:
	PC-1	CONCRETE PRECAST PANEL; PATTERN: SMOOTH FINISH COLOUR: TBC THROUGH SAMPLE PROCESS; SW7531 CANVAS TAN AS DESIGN BASIS
	PC-2	CONCRETE PRECAST PANEL; PATTERN: RANDOM STRIATED RIB (AP#311A) COLOUR: TBC THROUGH SAMPLE PROCESS; SW7068 GRIZZLE GRAY AS DESIGN BASIS
	PC-3	CONCRETE PRECAST PANEL; PATTERN: BRICK (2/65 DRAU) COLOUR: TBC THROUGH SAMPLE PROCESS; SW6061 TANBARK AS DESIGN BASIS
	PC-4	CONCRETE PRECAST PANEL PATTERN: LINEAR (2/63 WISLA) COLOUR: TBC THROUGH SAMPLE PROCESS; SW7531 CANVAS TAN AS DESIGN BASIS
	cw	RAICO CURTAIN CURTAIN WALL SYSTEM - PASSIVE HOUSE CERTIFIED UNIT
		DOUBLE THIN LINE DENOTES PANELISATION OF PRECAST PANELS
		DOUBLE RED LINEWORK DENOTES PANEL REVEALS IN FORMWORK.

Exterior Finishes Legend
1:50

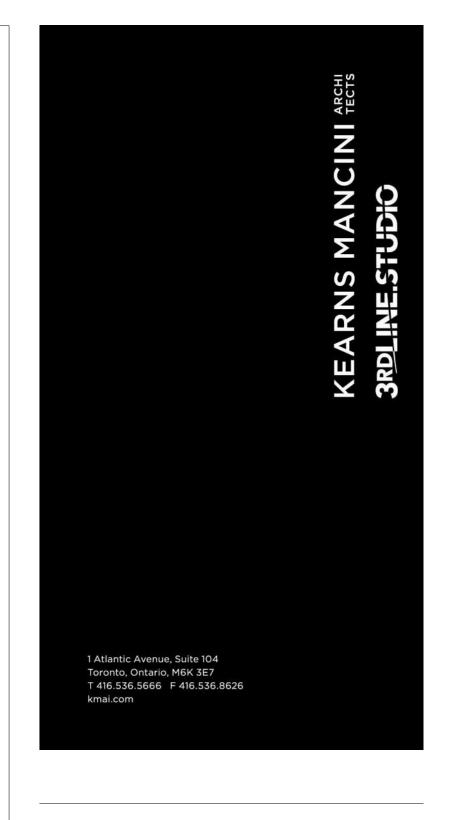



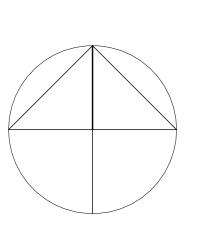

Greater Sudbury Capital Redevelopment

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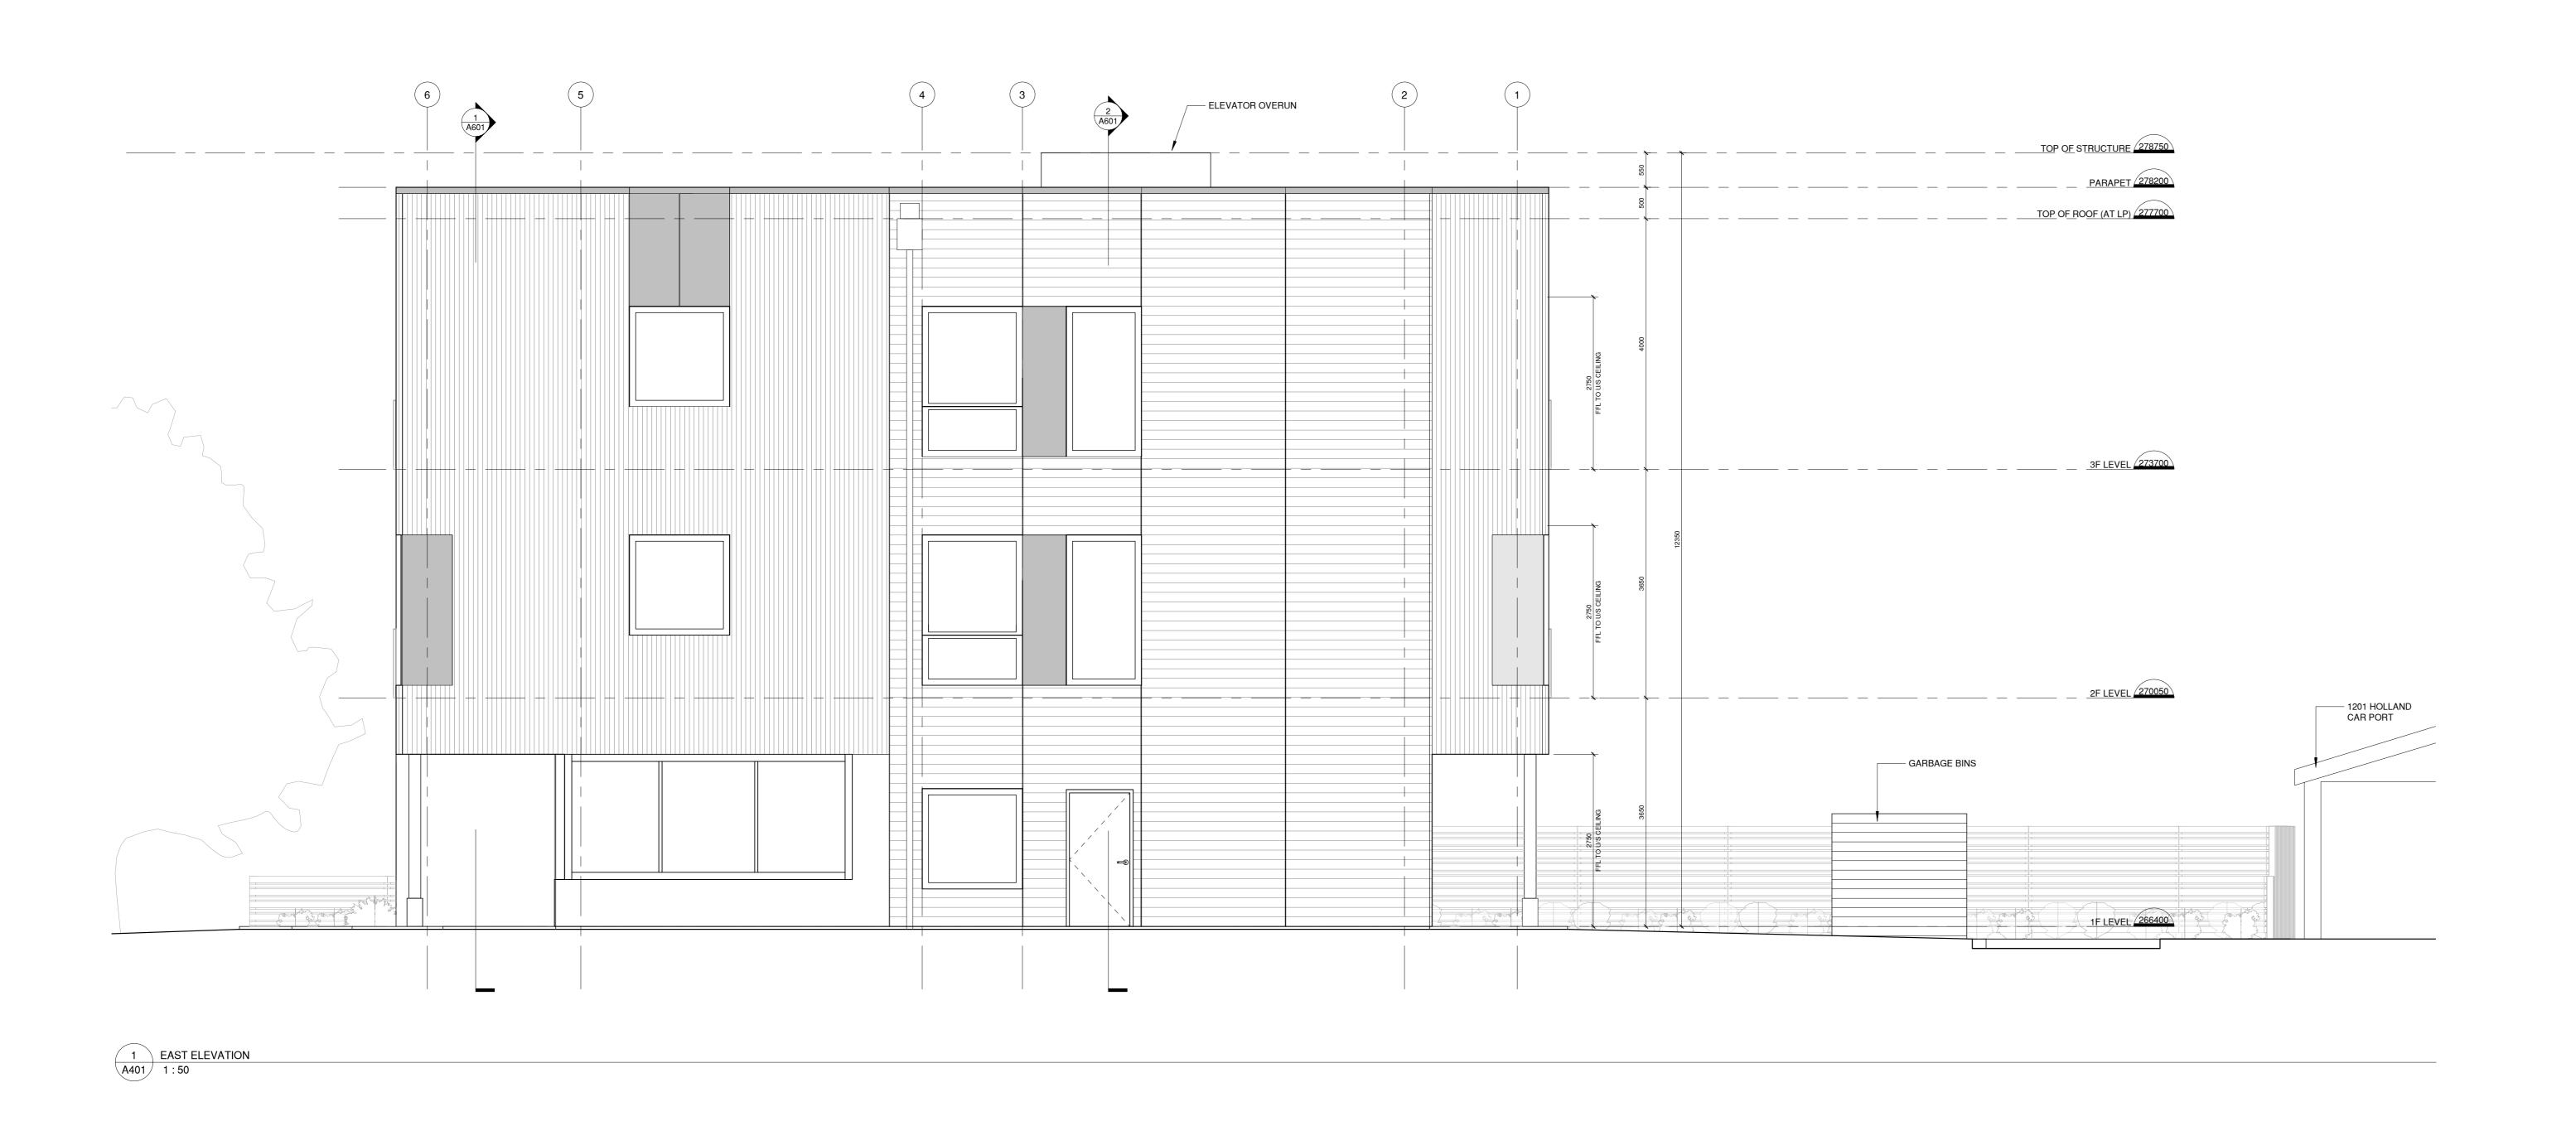
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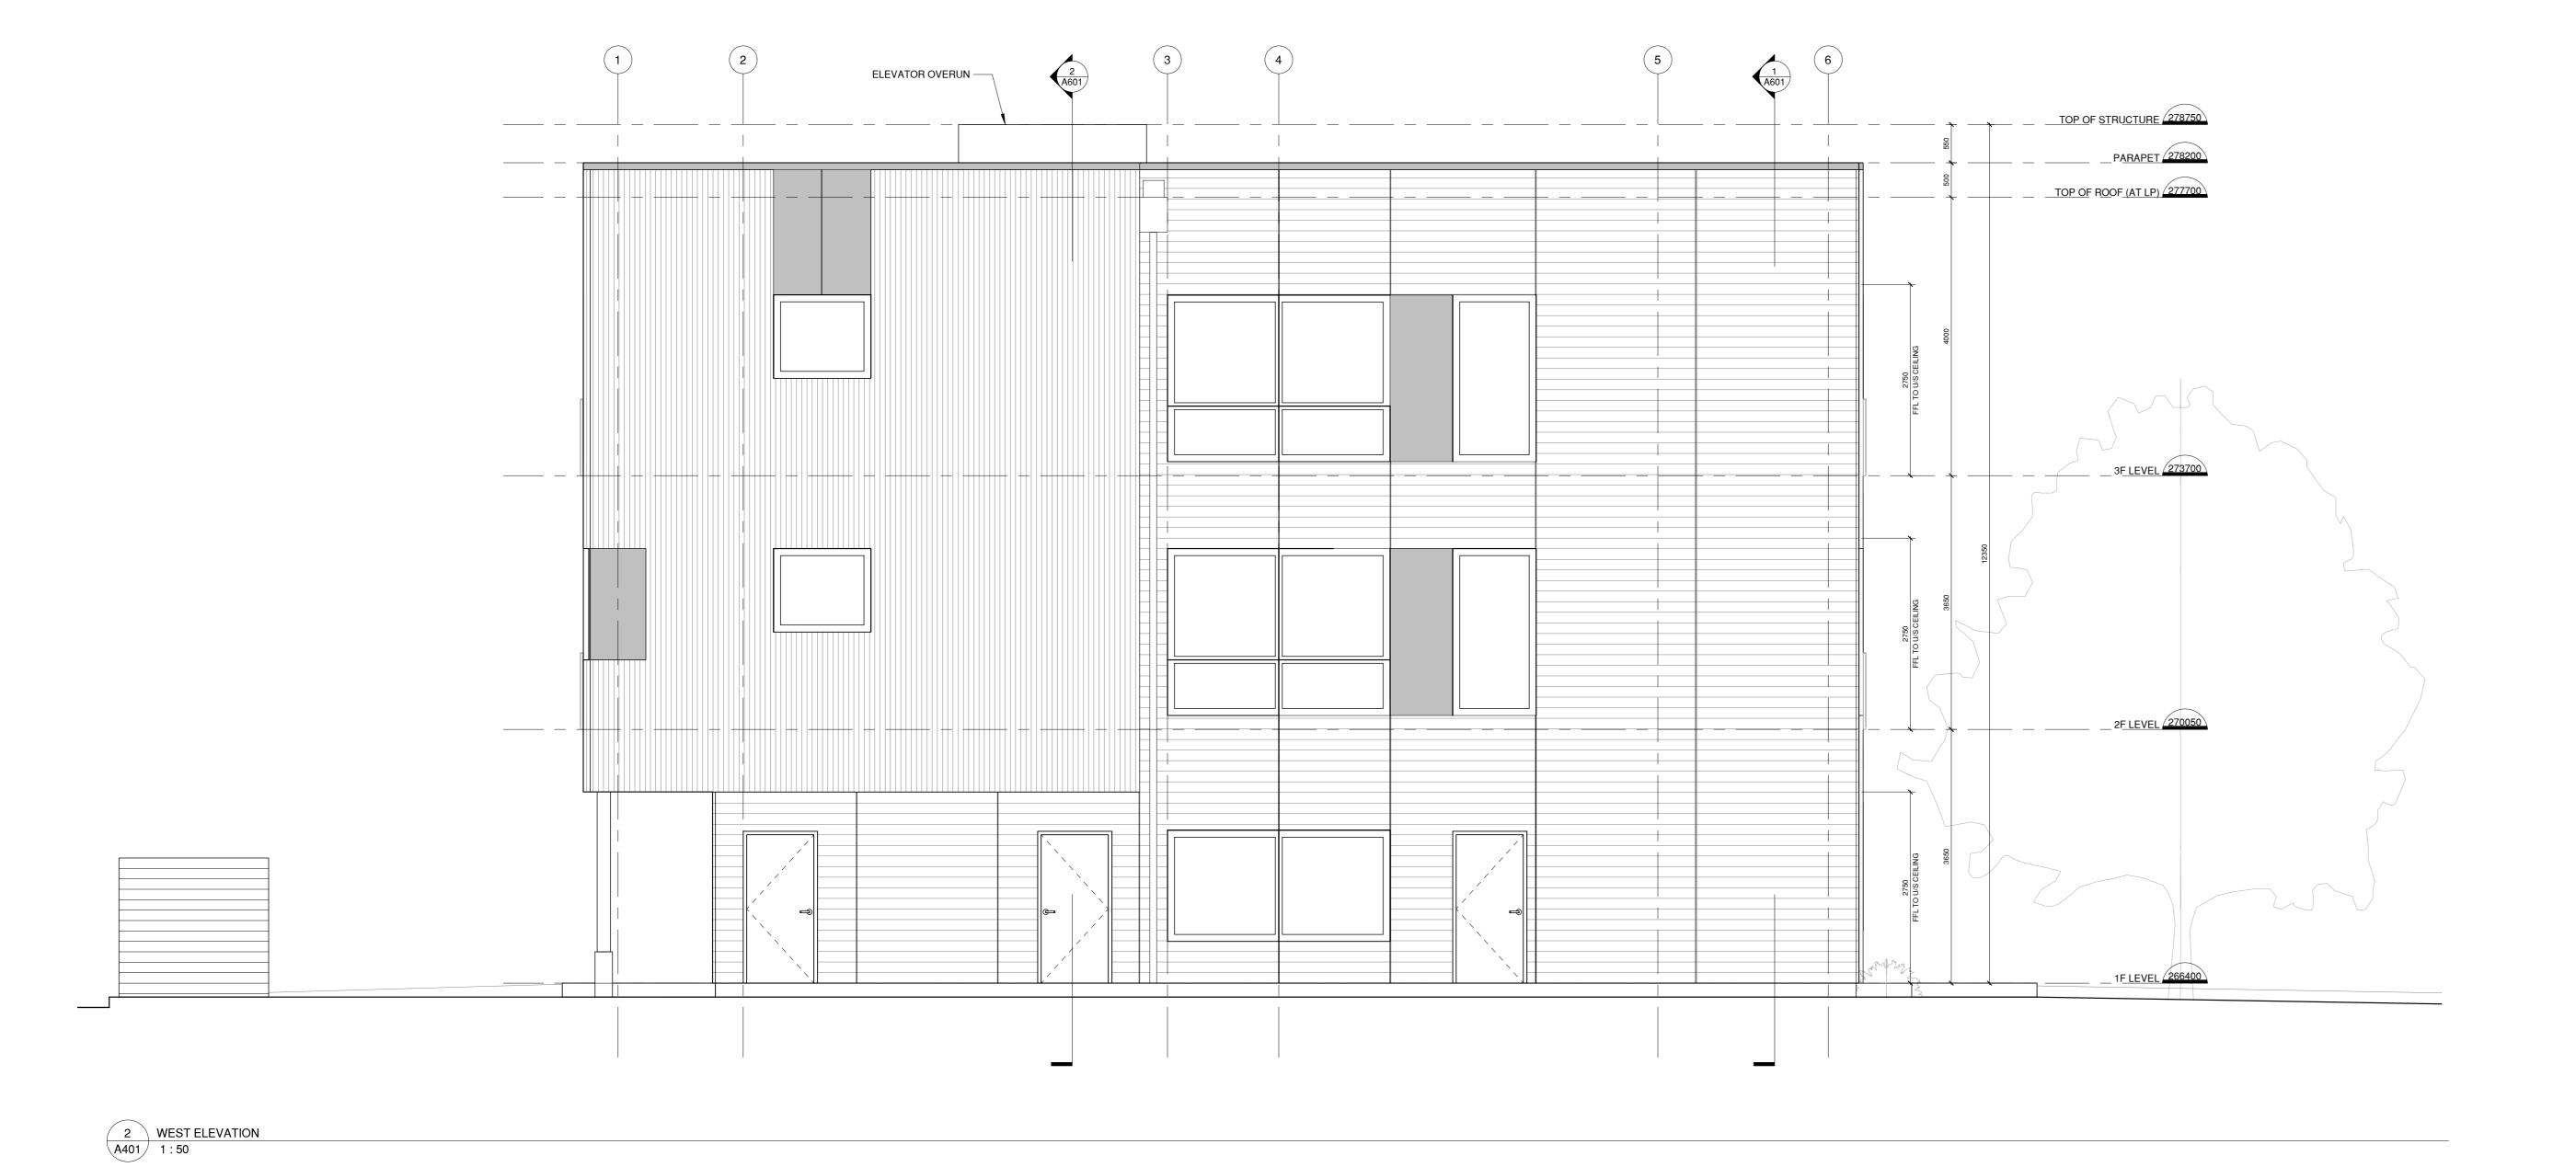
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Project No.

Drawing Nonth and South Building Elevations







EXTERIOR BUILD	ING MATER	RIAL LEGEND:
	PC-1	CONCRETE PRECAST PANEL; PATTERN: SMOOTH FINISH COLOUR: TBC THROUGH SAMPLE PROCESS; SW7531 CANVAS TAN AS DESIGN BASIS
	PC-2	CONCRETE PRECAST PANEL; PATTERN: RANDOM STRIATED RIB (AP#311A) COLOUR: TBC THROUGH SAMPLE PROCESS; SW7068 GRIZZLE GRAY AS DESIGN BASIS
	PC-3	CONCRETE PRECAST PANEL; PATTERN: BRICK (2/65 DRAU) COLOUR: TBC THROUGH SAMPLE PROCESS; SW6061 TANBARK AS DESIGN BASIS
	PC-4	CONCRETE PRECAST PANEL PATTERN: LINEAR (2/63 WISLA) COLOUR: TBC THROUGH SAMPLE PROCESS; SW7531 CANVAS TAN AS DESIGN BASIS
	CW	RAICO CURTAIN CURTAIN WALL SYSTEM - PASSIVE HOUSE CERTIFIED UNIT
		DOUBLE THIN LINE DENOTES PANELISATION OF PRECAST PANELS
		DOUBLE RED LINEWORK DENOTES PANEL REVEALS IN FORMWORK.

Exterior Finishes Legend
1:50



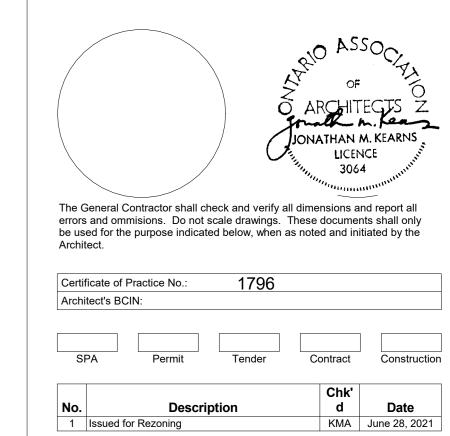

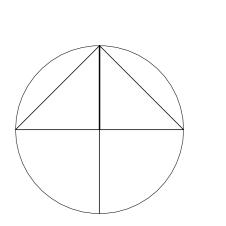

Greater Sudbury Capital Redevelopment

1310 Sparks Street Sudbury, ON

Scale 1:50

Date Plotted 6/24/2021 10:12:02 AM

Drawn Author


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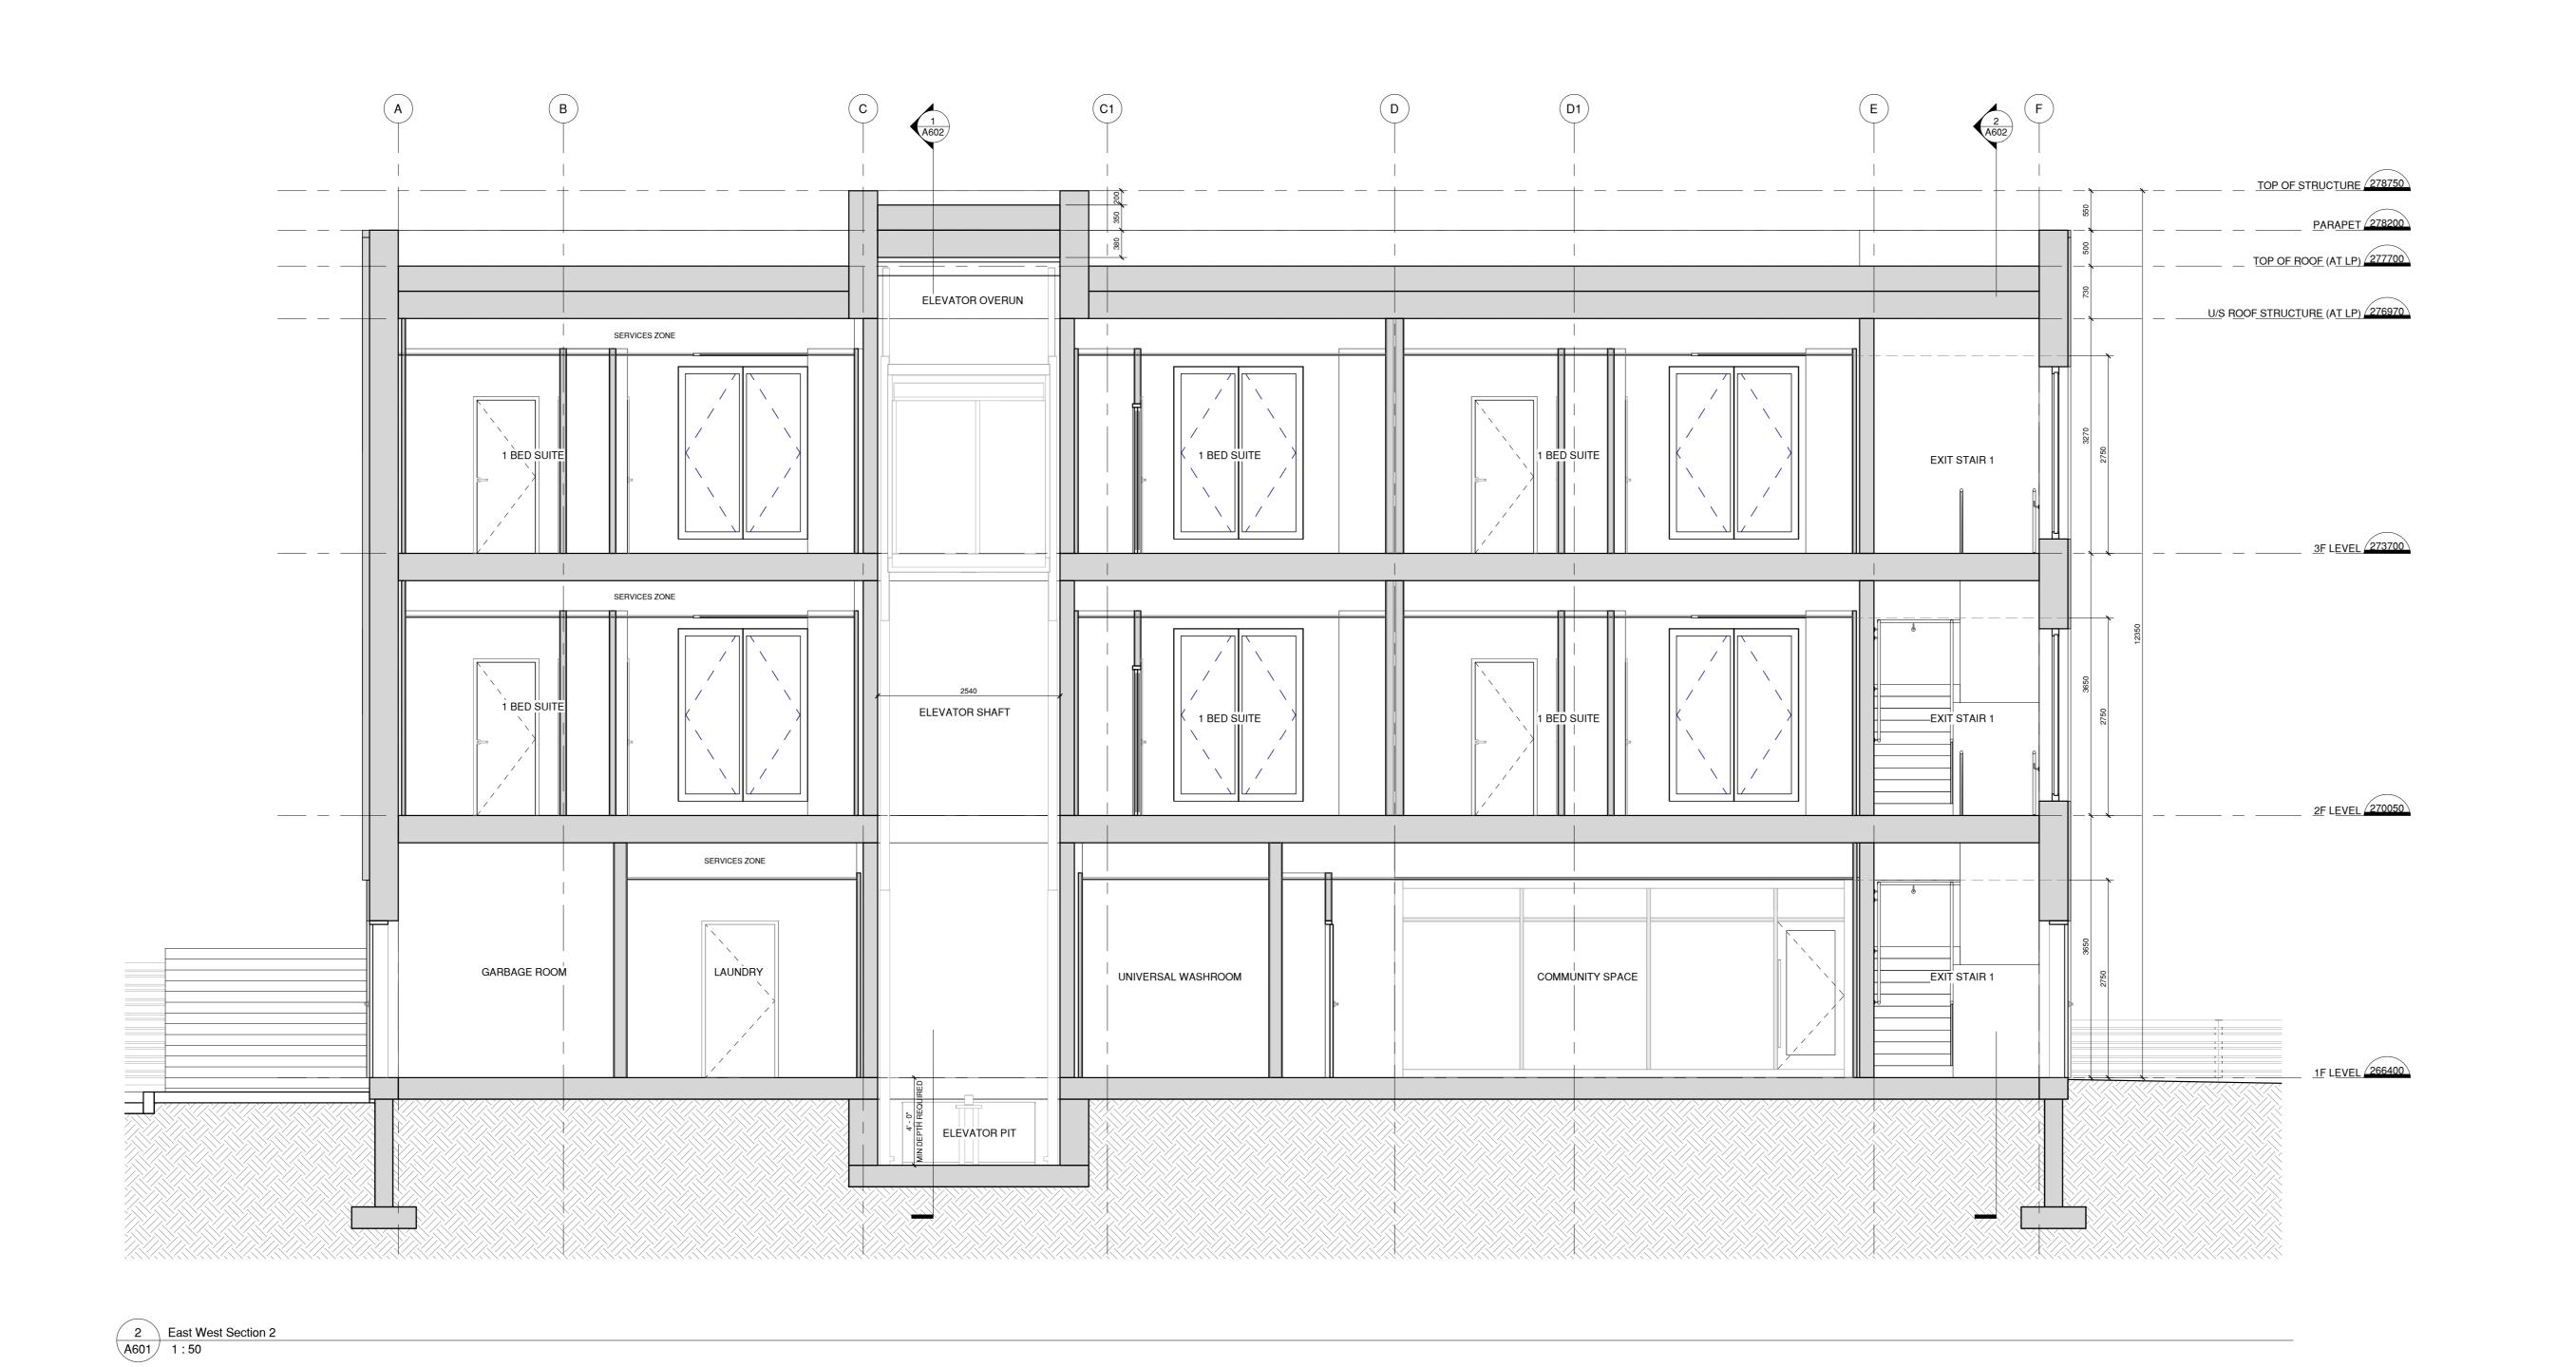
Project No.

Project No.


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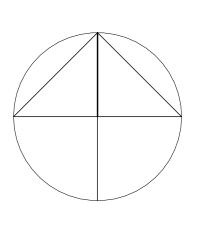
East and West Building Elevations





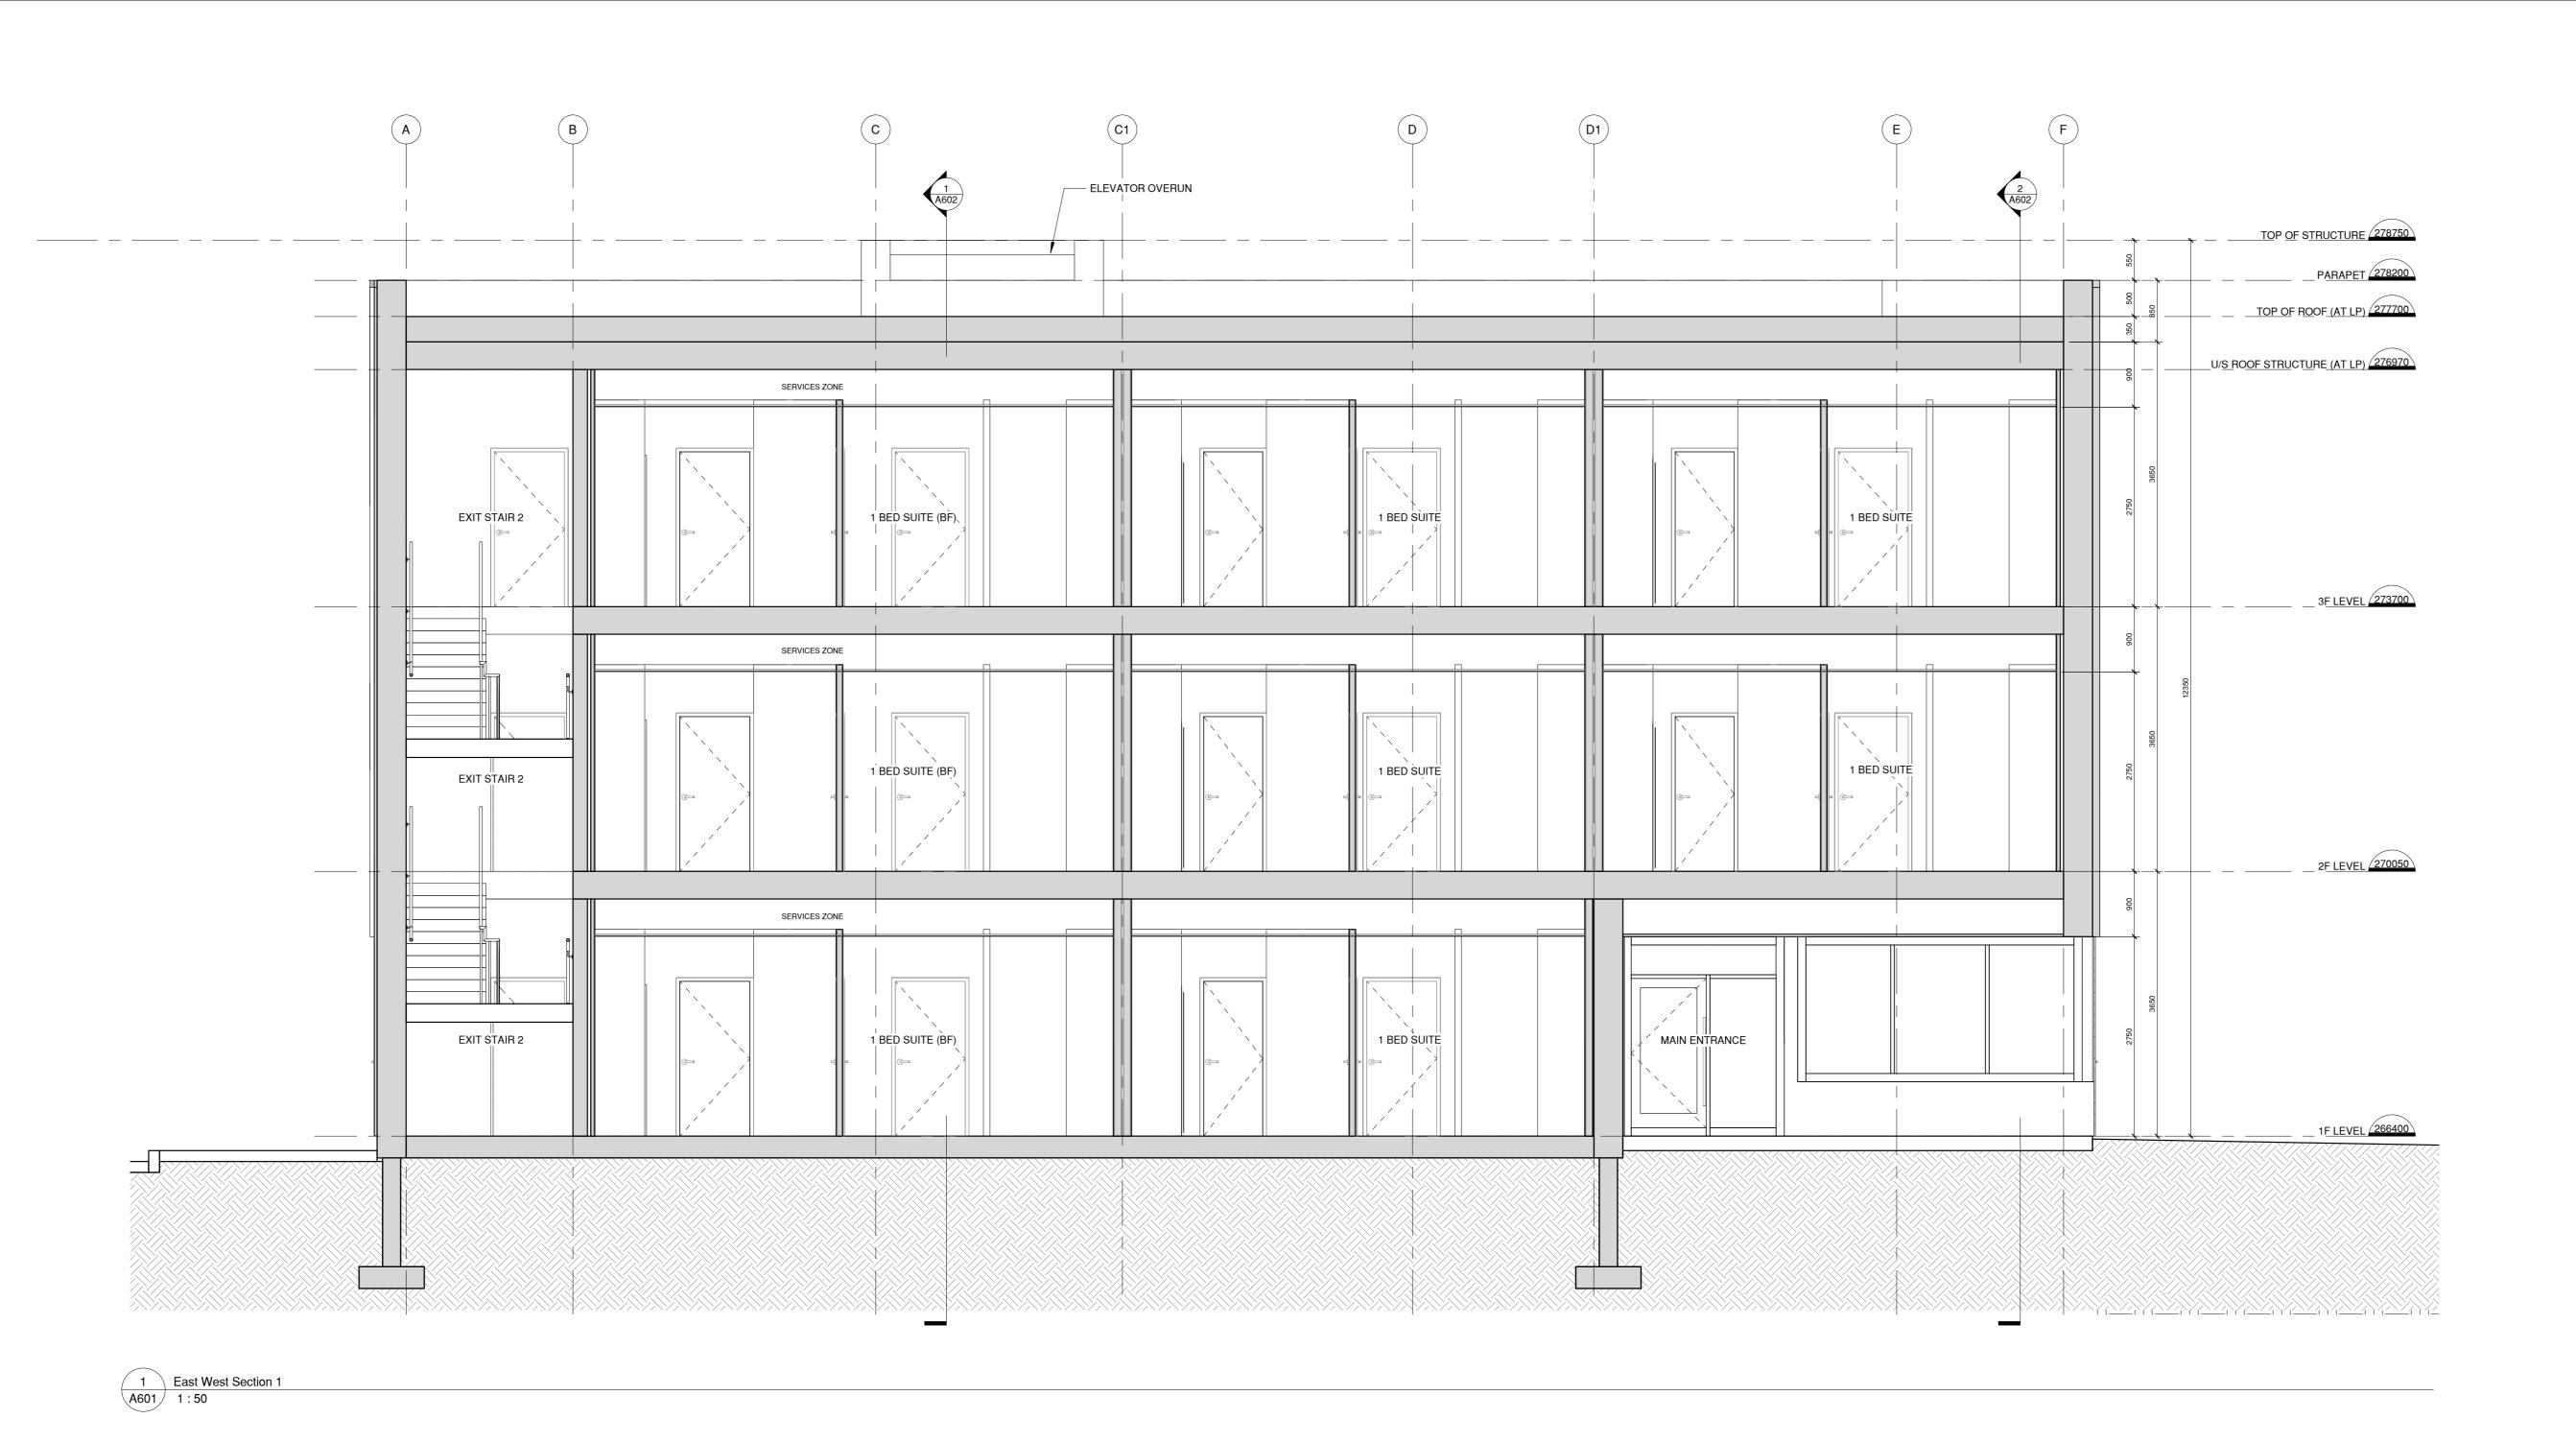



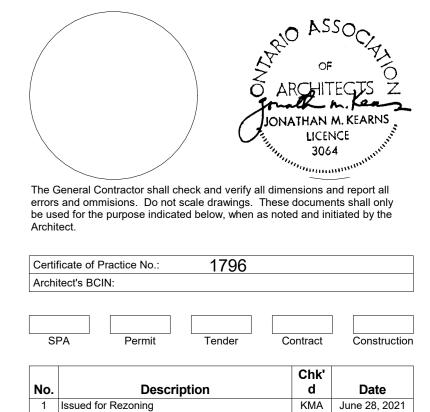

Greater Sudbury Capital Redevelopment

1310 Sparks Street Sudbury, ON

Scale 1:50

Date Plotted 6/24/2021 10:12:05 AM

Drawn Author


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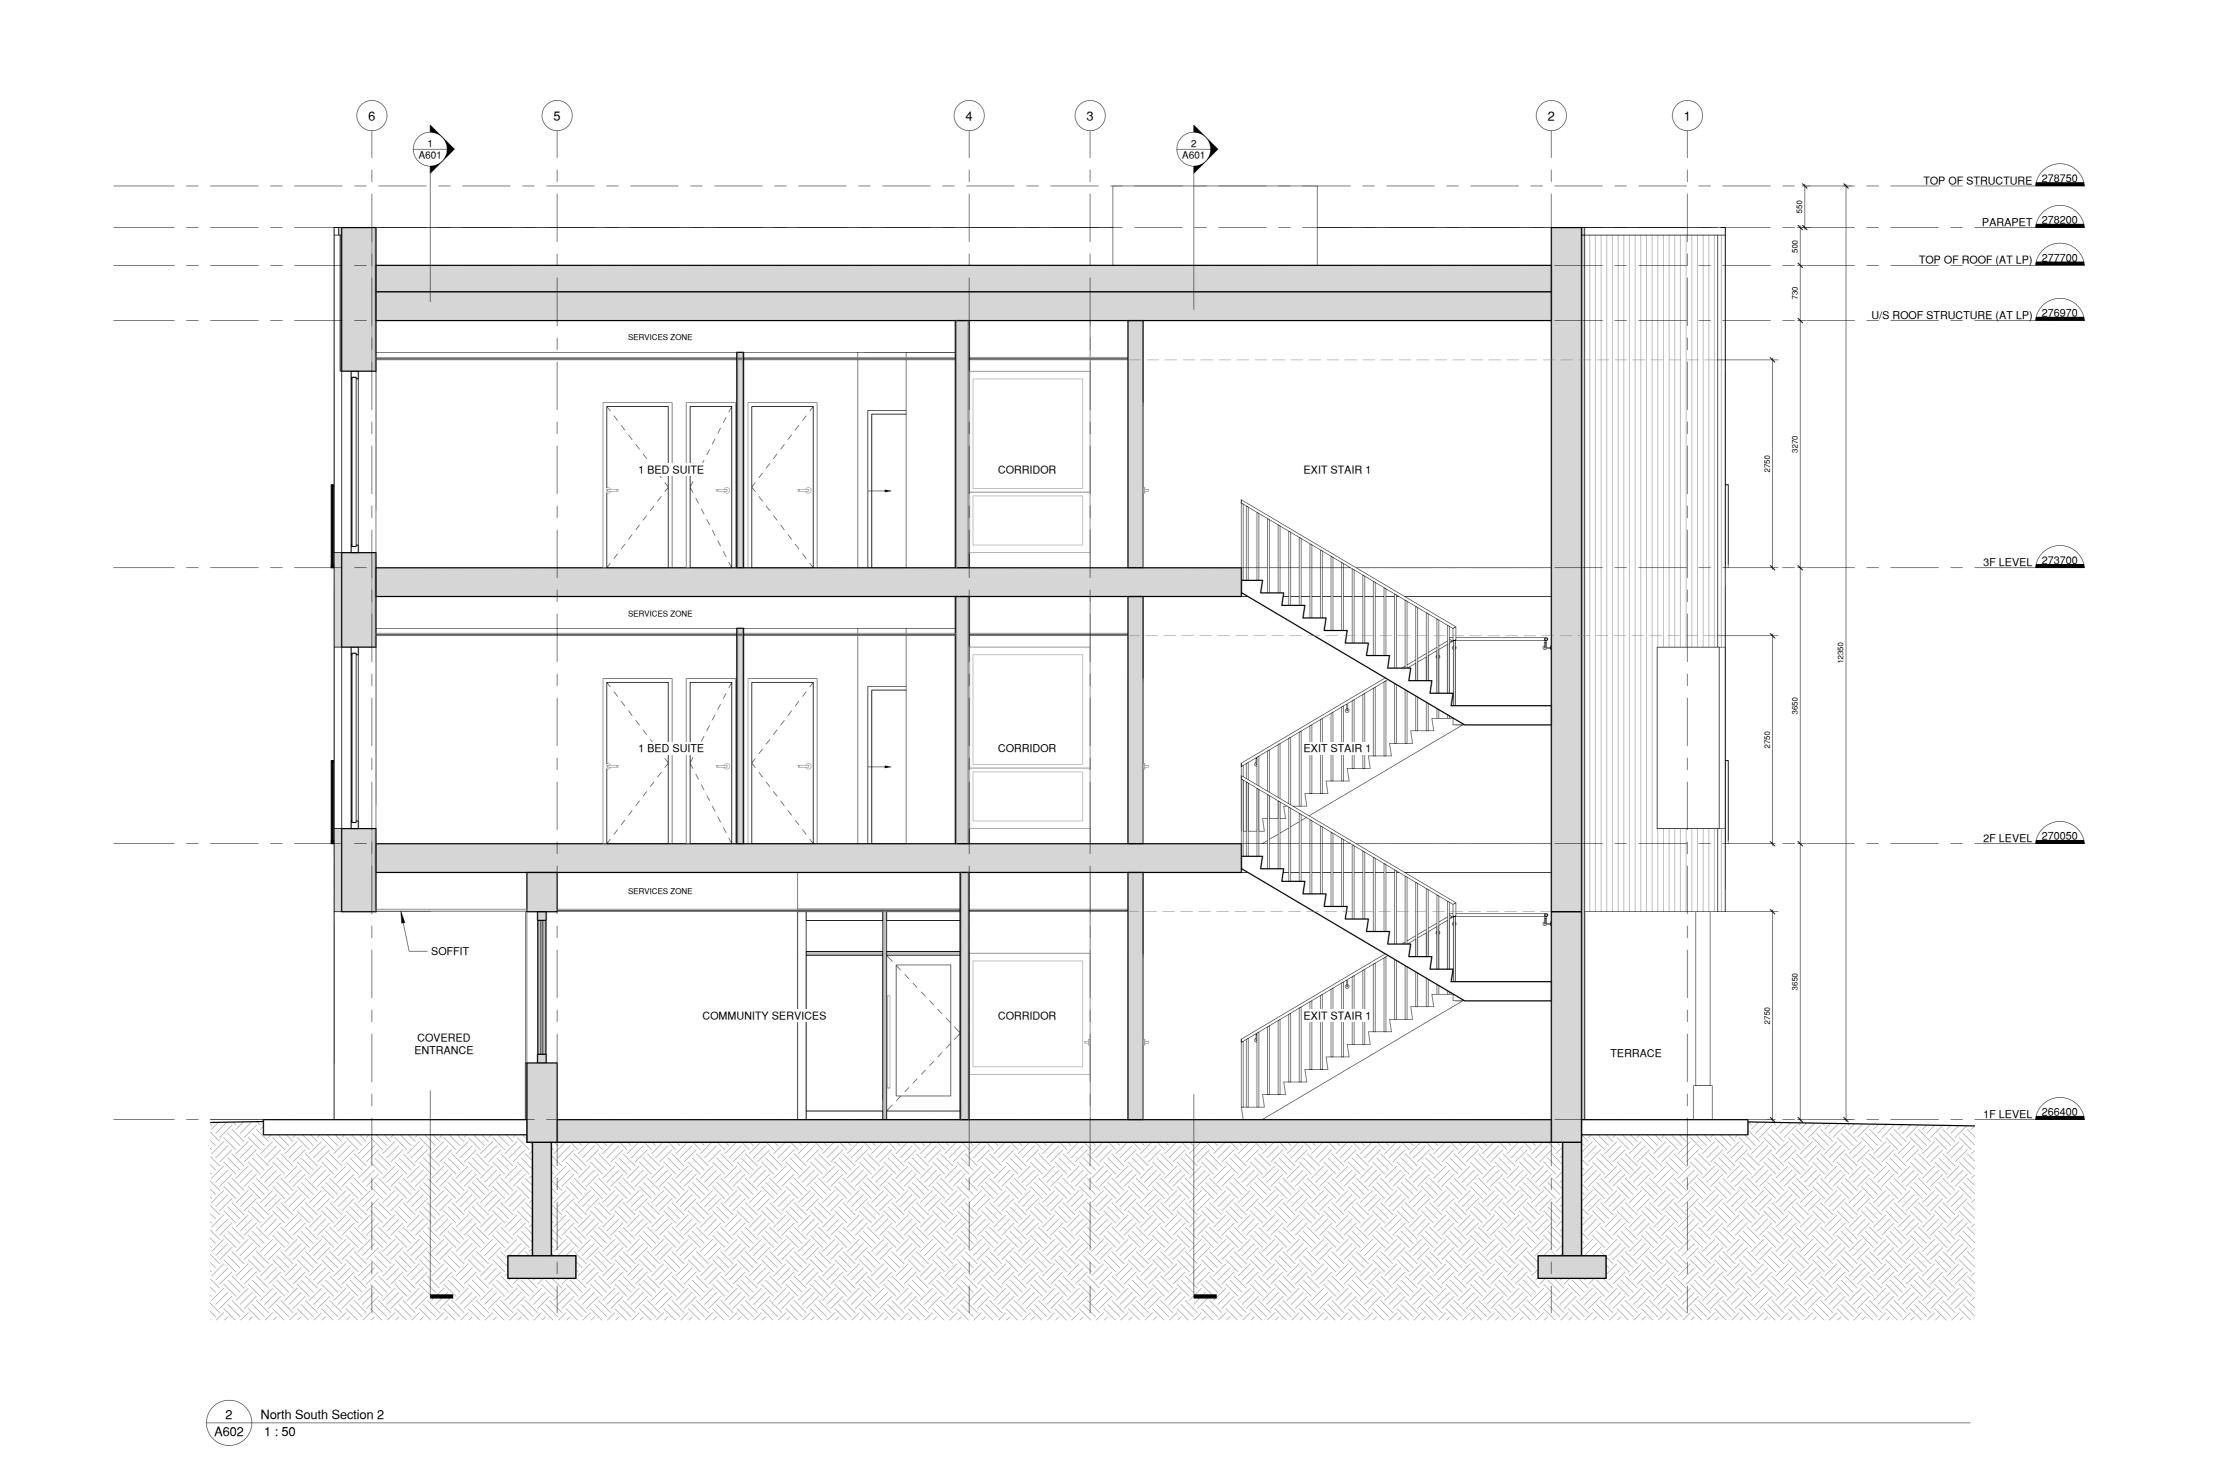
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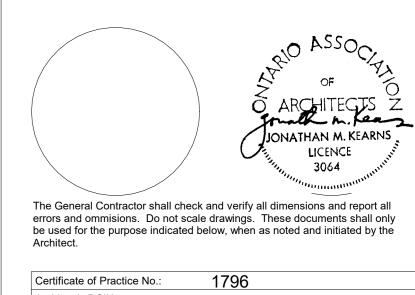
Fast West

East West Building Sections









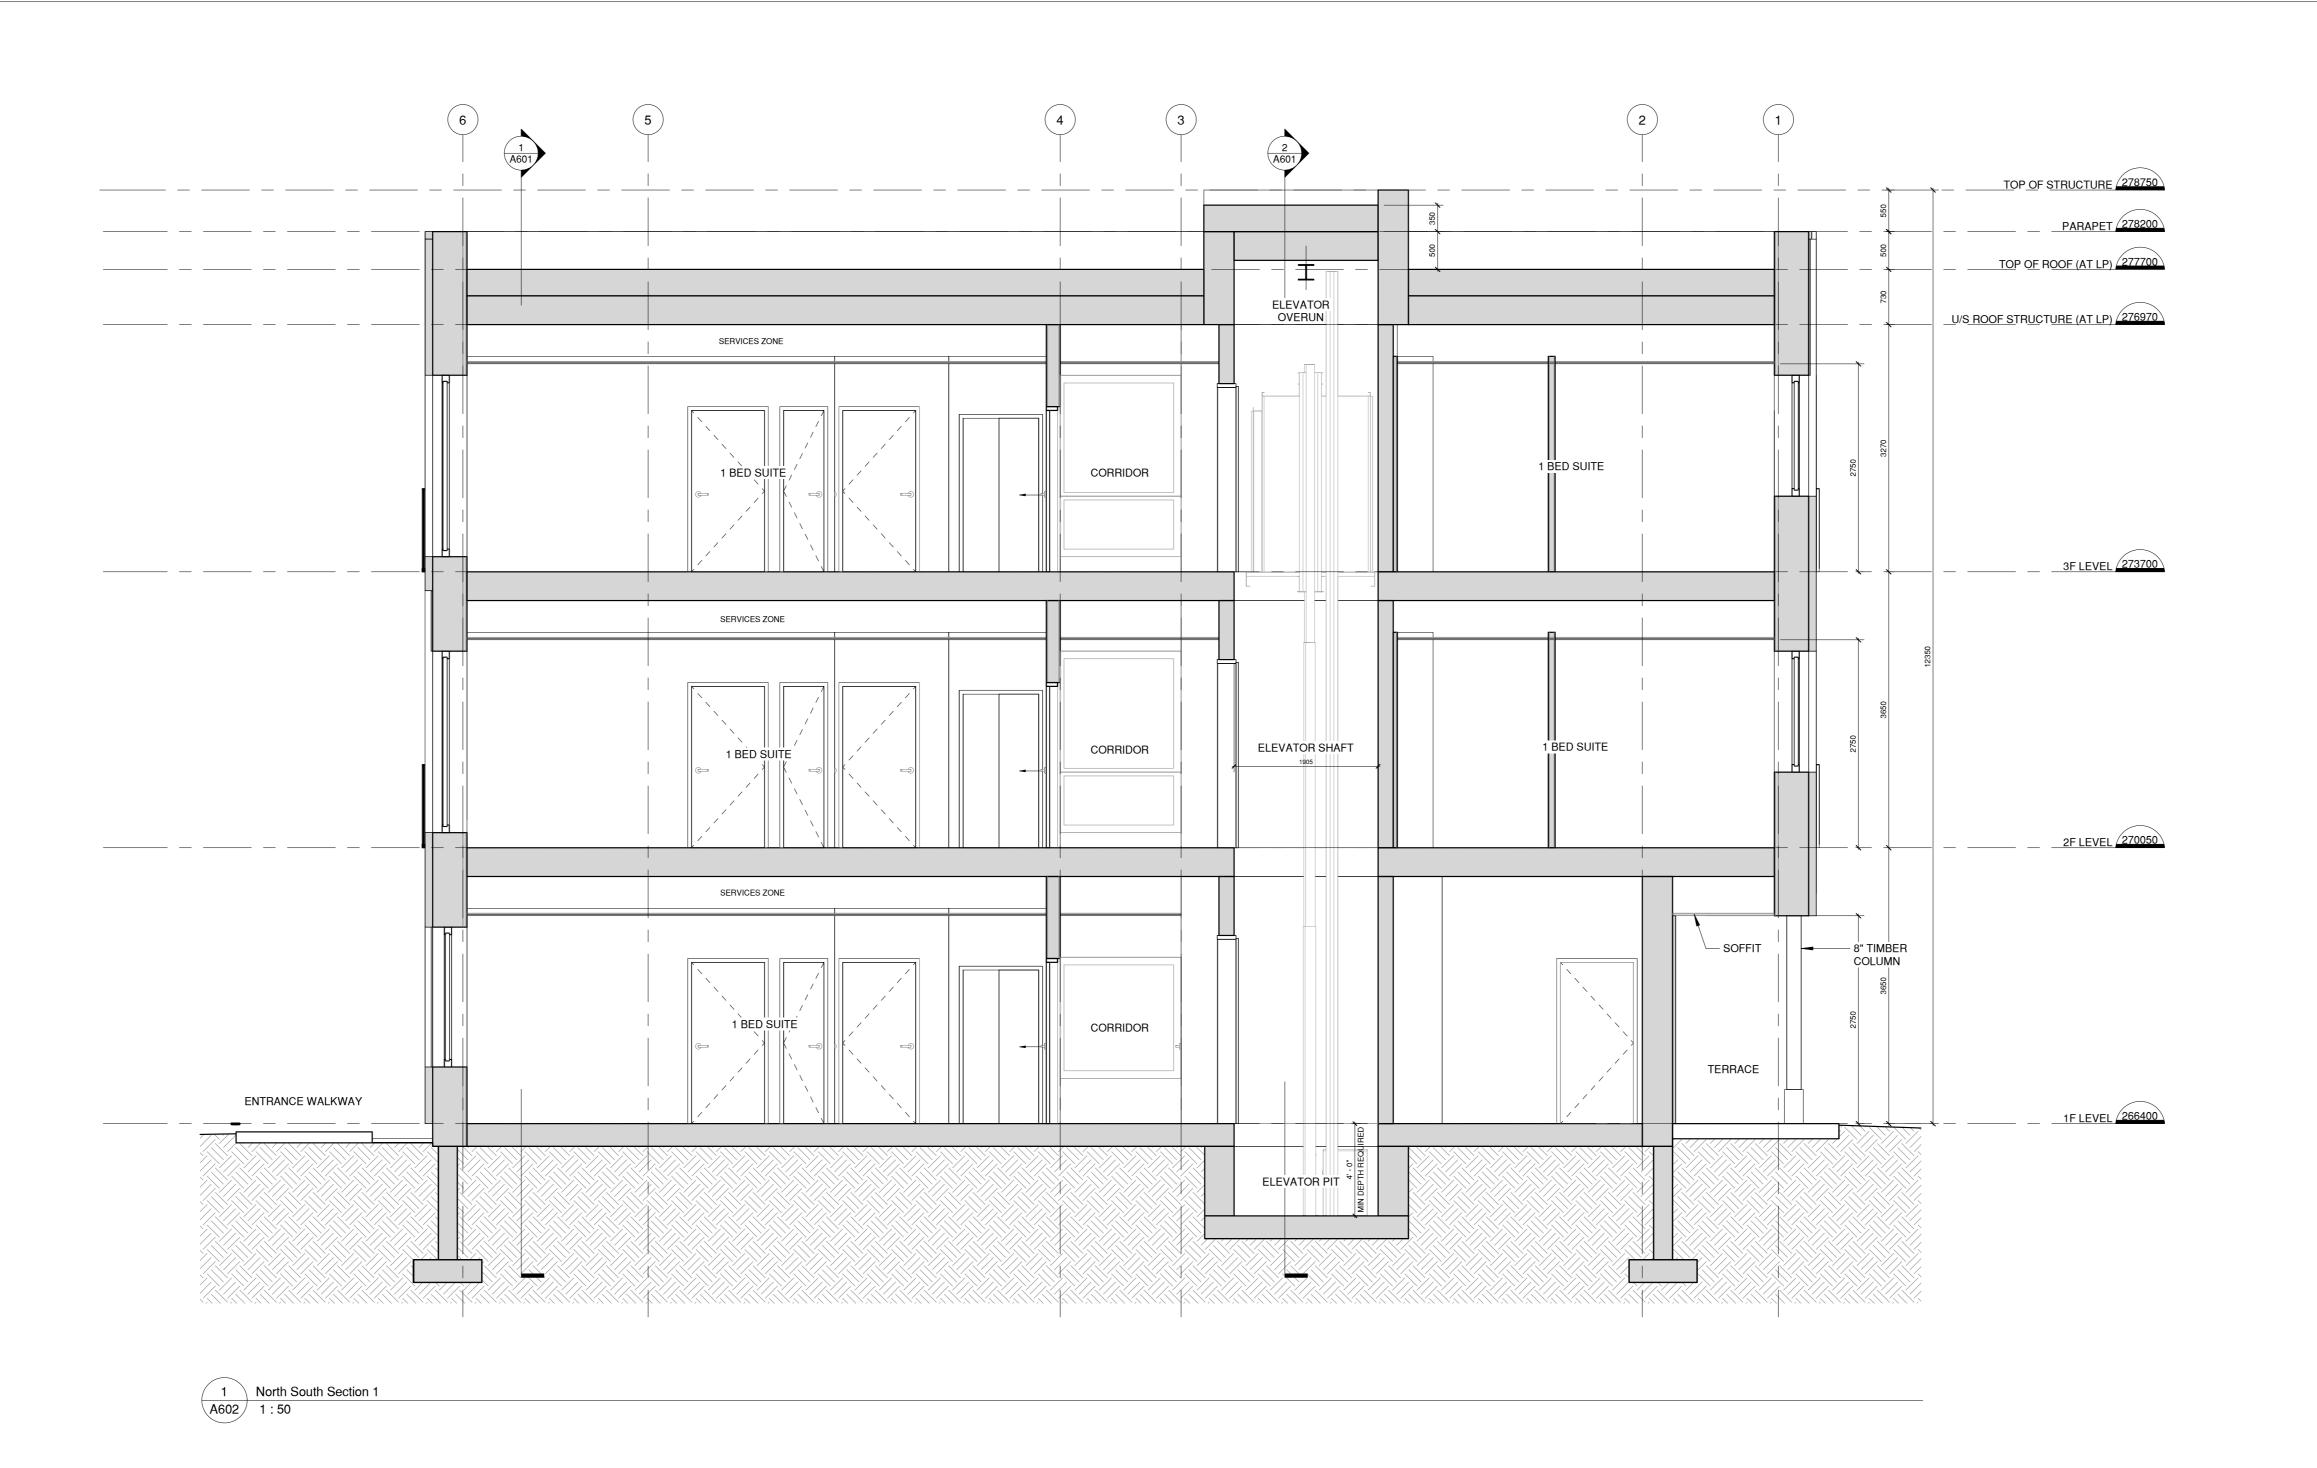

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Greater Sudbury Capital Redevelopment

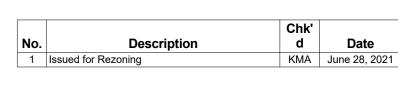1310 Sparks Street Sudbury, ON

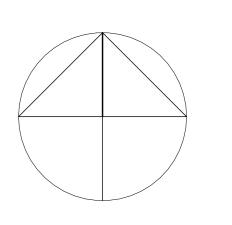 Scale
 1:50

 Date Plotted
 6/24/2021 10:12:08 AM

 Drawn
 Author

 Checked
 Checker

Project No.

Drawing No.

North South Building Sections










3 3D View 3 - South West Corner and Parking from Sparks Street
A900


A0_(841x1189) C:\Users\jondavies\Documents\21-014 1310 Sparks Street Sudbury_R1 - R2021_jondaviesCVAG6.rvt

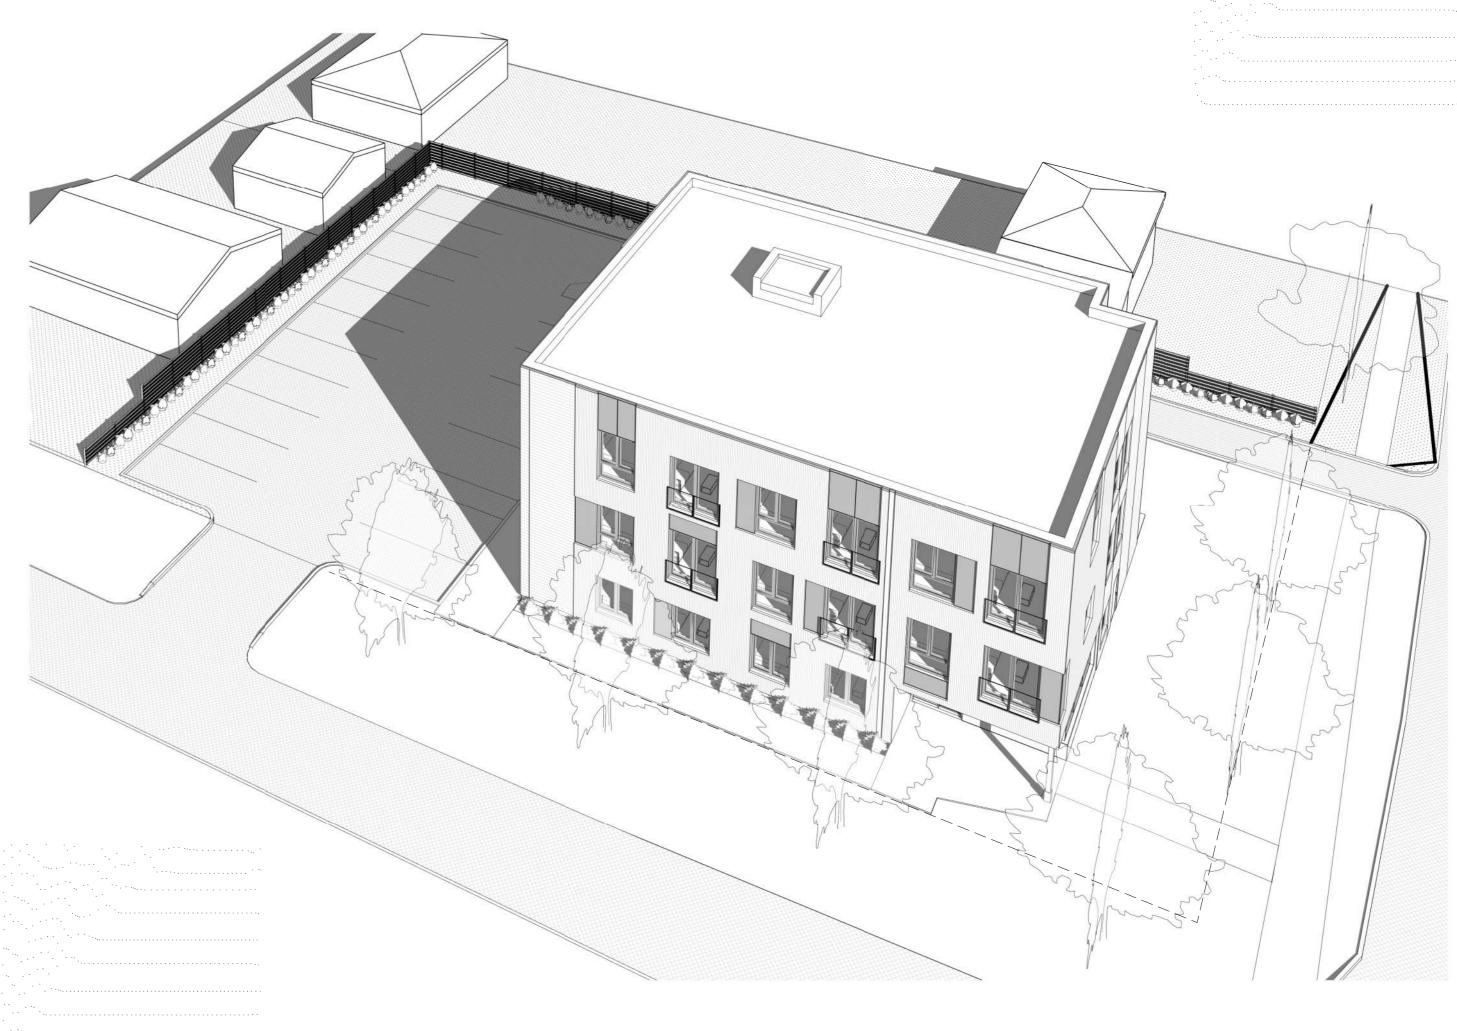

4 3D View 4 - Birds Eye from South East Corner A900

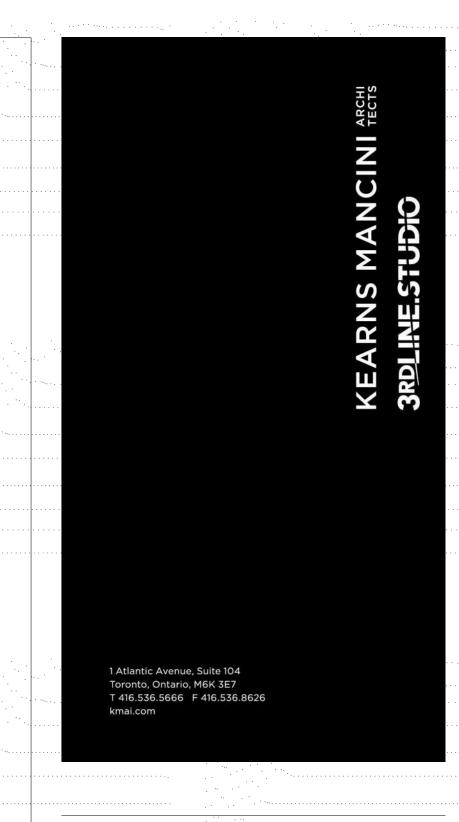

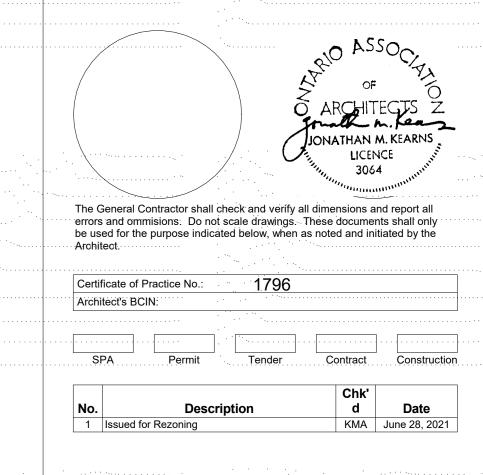

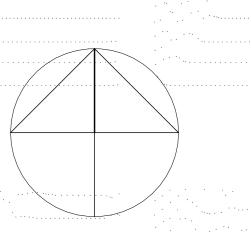

Greater Sudbury Capital Redevelopment

1310 Sparks Street Sudbury, ON

3D Perspective Views