

GENERAL NOTES:

- 1. INFORMATION PRESENTED ON THIS DRAWING IS BASED UPON INFORMATION RECEIVED FROM THE FOLLOWING SOURCES: - TOPOGRAPHICAL DETAILS: TULLOCH GEOMATICS - DEC, 2022
- THE CONTRACTOR SHALL BE RESPONSIBLE FOR LOCATING AND VERIFYING ALL EXISTING SERVICES AND UTILITIES PRIOR TO PROCEEDING WITH ANY WORK.
- 3. THE CONTRACTOR SHALL NOTIFY THE ENGINEER IMMEDIATELY OF ANY DISCREPANCIES.

 4. THE CONTRACTOR SHALL NOT OPERATE ANY EXISTING SERVICE VALVES WITHOUT CONTACTING AND OBTAINING PERMISSION FROM THE SPECIFIC UTILITY OWNER.
- THE CONTRACTOR SHALL VISIT THE SITE PRIOR TO PERFORMING ANY WORK AND MAKE THEMSELVES FULLY AWARE OF ALL EXISTING ON—SITE CONDITIONS.

- INHEMSELVES FULLY AWARE OF ALL EXISING ON-SITE CONDITIONS.

 6. ALL ELEVATIONS ARE IN METERS AND CAN BE CONVERTED TO FEET BY DIVIDING BY 0.3048.

 7. ALL PROPERTY BARS SHALL BE PRESERVED AND REPLACED BY A CERTIFIED OLS AT THE CONTRACTORS EXPENSE IF DISTURBED DURING CONSTRUCTION.

 8. DRAWINGS ARE NOT TO BE SCALED.

 9. ALL WORK TO BE CARRIED OUT IN ACCORDANCE WITH THE CITY OF GREATER SUDBURY STANDARDS AND OPS STANDARDS. WHERE CONFLICT OCCURS, CITY OF GREATER SUDBURY STANDARDS COVERN.

SILTATION CONTROL PLAN NOTES:

- SEDIMENT BARRIERS, CHECK DAMS, AND TEMPORARY CONSTRUCTION ACCESS TO BE INSTALLED PRIOR TO THE BEGINNING OF CONSTRUCTION.

 ALL SEDIMENT CONTROL DEVICES TO BE ROUTINELY INSPECTED AND MAINTAINED IN PROPER WORKING ORDER UNTIL AREAS ARE STABILIZED.

 IF NECESSARY, TRUCKS WILL BE WASHED DOWN BEFORE LEAVING THE SITE.

- 4. THE SITE WILL BE WET DOWN IF NECESSARY TO CONTROL DUST.
 5. ALL CONSTRUCTION ACTIVITY WILL COMPLY WITH THE CITY OF GREATER SUDBURY NOISE BYLAW.
 6. ALL CONSTRUCTION VEHICLES TO ENTER AND EXIT THE SITE FROM TEMPORARY CONSTRUCTION ACCESS.
- 7. ALL TOPSOIL STOCKPILES TO BE SURROUNDED WITH SEDIMENT CONTROL FENCING.
- A FILTER FABRIC TO BE PLACED UNDER GRATES ON ALL BASINS TO TRAP SEDIMENT. SILT TRAPS
 ARE TO BE CLEANED REGULARLY AND ARE NOT TO BE REMOVED UNTIL ALL CONSTRUCTION
 ACTIVITY IS COMPLETE. FILTER FABRIC FOR SILT CONTROL TO BE TERRA FIX 270R OR
 ADPROVED FOUNDALENT APPROVED FOUNALENT
- APPROVED EQUIVALENT.

 9. WHERE CONSTRUCTION ACTIVITY TAKES PLACE WITHIN THE CITY RIGHT OF WAY, SEDIMENT CONTROLS WILL BE PLACED ON THE CATCH BASINS ON PUBLIC STREETS ACROSS THE PROPERTY'S FRONTAGE.


 10. STREET SWEEPING, CATCH BASIN CLEANING AND DUST CONTROL ARE THE RESPONSIBILITY OF THE DEVELOPER AND MUST BE KEPT UNDER CONTROL ON ALL ROADWAYS TO THE SATISFACTION OF THE CITY OF GREATER SUDBURY.
- 11. SURFACE EROSION PROTECTION SHALL BE APPLIED FOR ALL DISTURBED AREAS, SUBJECT TO EROSION, UNTIL VEGETATION IS ESTABLISHED.

DRAINAGE NOTES:

- 1. SLOPE AWAY FROM THE BUILDING AT A MINIMUM 2.0% GRADE.
- SULPE AWAY FROM THE BUILDING AT A MINIMOM 2.026 GRADE.
 SWALES SHOWN TO DIRECT WATER AWAY FROM THE BUILDING AND THE ADJACENT PROPERTIES.
 WHERE MINIMUM SWALE GRADE IS LESS THAN 1.0%, UNDERDRAIN SHALL BE INSTALLED.
 MINIMUM 200mm HEIGHT FROM TOP OF FOUNDATION WALL TO FINISHED GRADE SHALL BE PROVIDED.

RETAINING WALLS:

- RETAINING WALLS SHALL BE DESIGNED BY OTHERS.
 RETAINING WALLS MAY REQUIRE A PERMIT AND ENGINEERING DRAWINGS. THE MUNICIPALITY SHALL BE CONTACTED REGARDING ANY ASSOCIATED PERMITS.
 CONSTRUCTION OF THE RETAINING WALL SHALL NOT COMMENCE UNTIL APPLICABLE PERMITS.
- 4. RETAINING WALL SHALL BE COMPLETE WITH GUARDS WHERE APPLICABLE IN ACCORDANCE WITH THE ONTARIO BUILDING CODE.

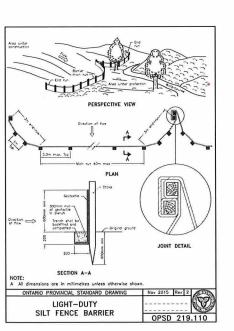







ENGINEER'S SEAL



	-		-	
- DATE	REV.	REVISION	BY	APP'

2538085 ONTARIO INC.

TULLOCH

PROJECT TITLE:

105 NOTRE DAME STREET DEVELOPMENT

DRAWING TITLE

LOT GRADING PLAN FOR SEVERANCE APPLICATION

Rev 2	BZ	BZ	PD	PD	
	DRAWN	DESIGNED	CHECKED	APPROVED	
219.110	1:	1:200		JAN 31, 2023	
	SC	SCALE		DATE	
SCALE 1:200	22-11	51 ()	C1	
0 3 6 9 12 M	ETRES				
	PROJECT	No. REVIS	SION	DRAWING	


CONCEPTUAL SKETCH NOTRE DAME & ST. THOMAS STREET GEOGRAPHIC TOWNSHIP OF AZILDA CITY OF GREATER SUDBURY 2023

REQUIRED RELIEF'S FOR REZONING (ROW DWELLINGS)

- FYS of 3m, whereas 6m is required Lot Coverage of 50%, whereas 40%
- is required
- 3m drive aisles, whereas 6m drive
- aisles are required Rear Privacy Yard of 4.5m, whereas 7.5m is required
- Parking Ratio of 1 parking space per unit, whereas a parking ratio of 1.5 parking spaces per unit is



TRE DAME STREE

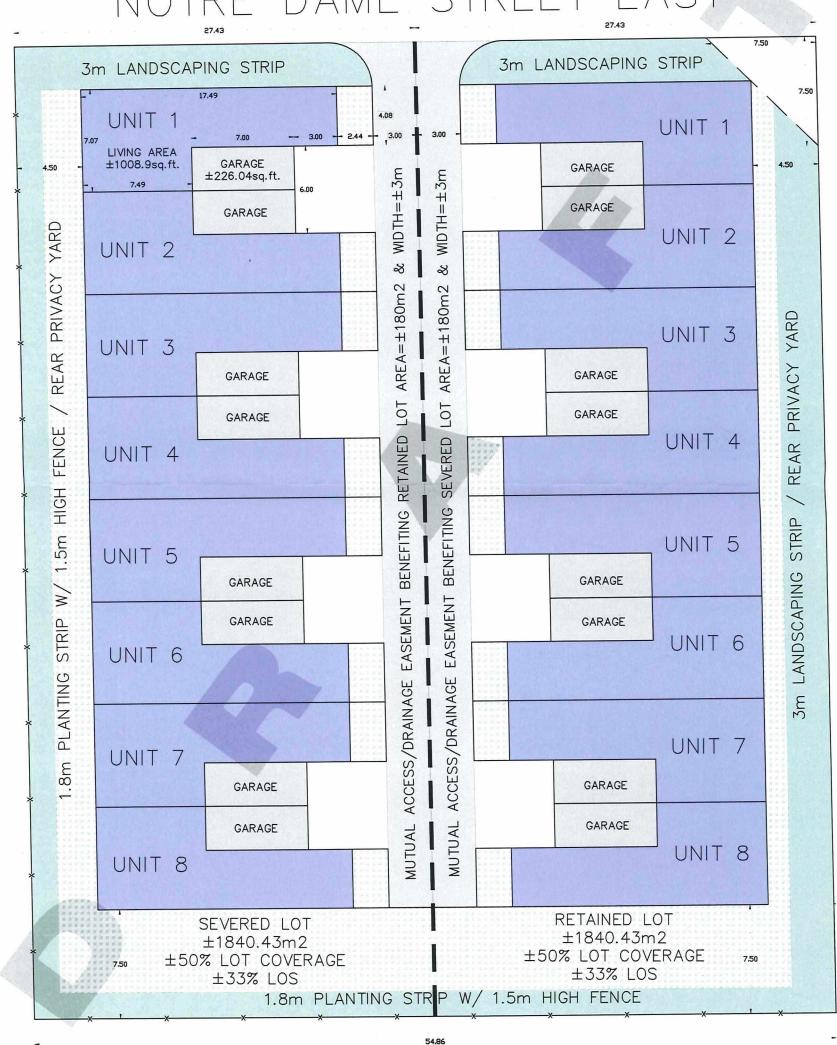

CAUTION


67.10

THE PROPERTY BOUNDARIES ILLUSTRATED ON THIS PLAN HAVE BEEN COMPILED FROM PLANS PROVIDED BY THE OWNER AND HAVE NOT BEEN CONFIRMED.

THIS SKETCH IS NOT A PLAN OF SURVEY AND SHALL NOT BE USED EXCEPT FOR THE PURPOSE INDICATED IN THE TITLE.

NO PERSON MAY COPY, REPRODUCE, DISTRIBUTE OR ALTER THIS PLAN IN WHOLE OR IN PART WITHOUT THE WRITTEN PERMISSION OF TULLOCH ENGINEERING. \circledcirc TULLOCH ENGINEERING, 2023.

NOTE: WASTE WILL BE COLLECTED PRIVATELY IN ACCORDANCE WITH SECTION 20 & 21 OF THE WASTE MANAGEMENT BY-LAW (2006-280)

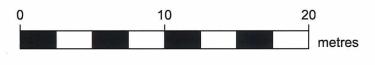



DRAWN BY: AA

FILE: 22-1151